


SOIL EROSION & SEDIMENTATION CONTROL NOTES:

GEOTEXTILE SILT FENCE OR SEDIMENT TRAPS SHALL BE PROVIDED AROUND CATCH BASIN COVERS WHERE DIRECTED BY THE ENGINEER TO PREVENT WASH OF SILT INTO THE STORM SEWER.

GEOTEXTILE SILT FENCE WILL BE INSTALLED WHERE DIRECTED BY THE ENGINEER TO PREVENT EROSION ON STEEP SLOPES DURING

FOR SOIL EROSION PROCEDURES, THE CONTRACTOR SHALL REFER TO THE MICHIGAN DEPARTMENT OF TRANSPORTATION FOR SOIL EROSION CONTROL NUMBER AS SHOWN ON MOOT STANDARD PLAN V-96D, SOIL EROSION AND SEDIMENTATION CONTROL MEASURES. SEDIMENT TRAPS WILL BE INCLUDED WITH THE RESPECTIVE DRAINAGE STRUCTURE ITEM.

AVOID UNNECESSARY DISTURBING OR REMOVING OF EXISTING VEGETATED TOPSOIL OR EARTH COVER. THESE COVER AREAS ACT AS SEDIMENT FILTERS. ALL TEMPORARY SOIL EROSION PROTECTION SHALL REMAIN IN PLACE UNTIL REMOVAL IS REQUIRED FOR FINAL CLEAN-UP AND APPROVAL.

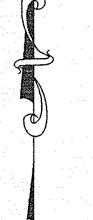

O = SET IRON = FOUND IRON T/C = TOP CURB

G = GUTTER--- = GAS LINE -- = OVERHEAD ELECTRIC &

TELEPHONE W---- = WATER LINE യ = POWER POLE

 \bowtie = WATER VALVE

PROJECT NOTES

DESCRIPTION:

FLOOR AREA

LOT 59 PLAT OF THE VILLAGE OF EDWARDSBURG, CASS COUNTY, MICHIGAN,

"R-I" ZONING DISTRICT

ZONING REQUIREMENTS:

			and the state of the state of			and the second second	ert vila de la la compa
			REC	RUIRED	and the second second	PROPOS	ED
FRONT	YARD SETE	ACK	2	0 '		15' (EXIS	5T.)
SIDE YA	ARD SETBA	CK	. 3	0 '		9 '	
REAR Y	ARD SETBA	ACK	2	5'		138'	
LOT AR	EA	- V - 2	20,000	50, F	T.(MIN.)	±16,644	SQ. FT.
	G COVERA		30%	(MAX.)	en e	21%	
LOT WIL	OTH AT BUIL	DING LINE	100'	(MIN.)	Jan 1. 1	143'	
BUILDI	ng infor	RMATION					
USE GRO	OUP-		A-3		- 4-0-1		
CONSTR	RUCTION TYP	?E-	5B				
NUMBER	OF STORIE	:5-	1				del de la company
PROPOS	SED TOTAL	BUILDING					

3295 SQ. FT.

PROJECT NOTES:

HYDROMULCHING WATER UNTIL GRASS IS ESTABLISHED.

PLANNING COMMISSION AND BOARD OF ADJUSTMENT APPROVALS HAVE BEEN OBTAINED.

ALL CONTRACTORS SHALL VISIT THE JOB SITE PRIOR TO BIDDING THE PROJECT TO UNDERSTAND ALL CONDITIONS

THE GENERAL CONTRACTOR SHALL BE RESPONSIBLE FOR OBTAINING ALL PERMITS, PERMIT COSTS, TAP FEES, METER DEPOSITS, BONDS, AND ALL OTHER FEES REQUIRED FOR PROPOSED WORK TO OBTAIN OCCUPANCY.

THE CONTRACTOR SHOULD NOTE THAT MACHINE GRADING MODIFIED SHALL INCLUDE THE REMOVAL OF ALL BRUSH AND MISCELLANEOUS ITEMS AS REQUIRED. ALL REQUIRED EARTH EXCAVATION, EMBANKMENT, AND ALL OTHER OPERATIONS NECESSARY TO DEVELOP THE DESIRED CROSS SECTION. ALL TOPSOIL REMOVED MAY BE STOCKPILED AND REUSED AS TOPSOIL SURFACE-3".

THE PROPOSED SEPTIC SYSTEM SHALL BE DESIGNED BY THE CASS COUNTY HEALTH DEPARTMENT, UPON APPLICATION BY CONTRACTOR. THE INSTALLATION OF THE SYSTEM SHALL BE THE RESPONSIBILITY OF THE CONTRACTOR.

CONTRACTOR SHALL PROVIDE CLASS A SEEDING-200#/ACRE, MULCH-2T/AGRE, CHEMICAL FERTILIZER NUTRIENT-300#/ACRE, AND TOPSOIL SURFACE-3" IN ALL DISTURBED AREAS NOT PAVED. AFTER THE TOPSOIL SURFACE IS INSTALLED, IT SHALL BE RAKED TO FORM A SMOOTH LAWN SURFACE, AND ALL STONES LARGER THAN 1/2" SHALL BE REMOVED, AND THEN ROLLED BEFORE SEEDING. SEED, MULCH, AND FERTILIZER SHALL BE APPLIED THRU

CONTRACTOR TO PROVIDE STRAW BALE DAMS OR SILT FENCES ACROSS ALL DITCHES, SMALES, AND ROUGH CUT ROADS WHICH EXIT FROM THE SITE TO ELIMINATE SEDIMENT RUNOFF. PROVIDE SEDIMENT BASINS WITH STRAW BALE DAMS OR SILT FENCES AROUND ALL STORM SEWER STRUCTURES DURING CONSTRUCTION.

CONTRACTOR TO AVOID UNNECESSARY DISTURBING OR REMOVING EXISTING VEGETATED TOPSOIL, OR EARTH COVER CONTRACTOR SHALL OBTAIN, AND PAY ALL FEES FOR THE SOIL EROSION CONTROL PERMIT

ALL TEMPORARY SOIL EROSION PROTECTION SHALL REMAIN IN PLACE UNTIL REMOVAL IS REQUIRED FOR FINAL

ALL 3" DIAMETER OR LARGER MATERMAINS MUST BE CLASS 52 DUCTILE IRON PIPE. ALL LINES UNDER 3" DIAMETER TO BE TYPE "K" COPPER OR GALVANIZED STEEL WITH WROUGHT IRON FITTINGS TO WITHIN 5 OF BUILDING, PROVIDE 5' MINIMUM COVERAGE FROM FINISHED GRADE. MAINTAIN IO FOOT MINIMUM HORIZONTAL SEPARATION BETWEEN THE SANITARY SEMER AND THE WATERMAIN. MAINTAIN A 18" MINIMUM VERTICAL CLEARANCE BETWEEN THE SANITARY SEMER AND THE WATERMAIN, AND ALL OTHER UTILITIES. PROVIDE FITTINGS AS REQUIRED.

CONNECTION TO EXISTING SEWER AND WATER MUST BE MADE IN ACCORDANCE WITH LOCAL REQUIREMENTS JONTACT CITY PRIOR TO MAKING CONNECTION.

ALL WATER LINES MUST BE INSTALLED AND TESTED IN ACCORDANCE WITH MICHIGAN DEPARTMENT OF PUBLIC HEALTH AND LOCAL HEALTH DEPARTMENT REQUIREMENTS.

ALL TESTING OF SEVER AND WATER MUST BE WITNESSED BY AN ENGINEER

SLOPE ALL GRADING UNIFORMLY FROM BACK OF CURB AT STREET EXISTING OR PROPOSED GRADES. IN AREAS WHERE NO CURBING IS PROPOSED, UNIFORMLY SLOPE PROPOSED GRADE TO EXISTING GRADE.

ALL CONSTRUCTION SIGNING TO BE IN ACCORDANCE WITH THE MICHIGAN MANUAL OF UNIFORM TRAFFIC CONTROL DEVICES. THE CONTRACTOR SHALL LOCATE ALL ACTIVE UNDERGROUND UTILITIES PRIOR TO STARTING WORK, AND SHALL CONDUCT

HIS OPERATIONS IN A MANNER AS TO ENSURE THAT THOSE UTILITIES NOT REQUIRING RELOCATION WILL NOT BE DISTURBED.

FOR PROTECTION OF UNDERGROUND UTILITIES, AND IN CONFORMANCE WITH PUBLIC ACT 38, 1974, THE CONTRACTOR SHALL DIAL 1-800-482-7171 A MINIMUM OF THREE FULL WORKING DAYS, EXCLUDING SATURDAYS, SUNDAYS, AND HOLIDAYS PRIOR TO BEGINNING EACH EXCAVATION IN AREAS WHERE PUBLIC UTILITIES HAVE NOT BEEN PREVIOUSLY LOCATED MEMBERS WILL THUS BE ROUTINELY NOTIFIED. THIS DOES NOT RELIEVE THE CONTRACTOR OF THE RESPONSIBILITY OF NOTIFYING UTILITY OWNERS WHO MAY NOT BE A PART OF THE "MISS DIG" ALERT SYSTEM.

THE CONTRACTOR SHALL INSTALL A PEDESTRIAN FENCE AROUND ALL EXCAVATIONS TO BE LEFT OPEN OVER NIGHT AS REQUIRED.

ALL FILL FOR THIS PROJECT MUST BE OBTAINED AND FURNISHED BY THE CONTRACTOR. ALL REQUIRED FILL SHALL BE SELECTED EXCAVATED MATERIAL FROM THE SITE APPROVED BY THE ENGINEER OR MOOT CLASS II GRANULAR MATERIAL FROM BORROW. NOTE: NO BORROW HAS BEEN PRE-ARRANGED BY THE OWNER, EXCESS FILL SHALL BE REMOVED FROM THE SITE BY THE CONTRACTOR.

ANY SANITARY SEWER, SANITARY SEWER SERVICE LEADS, WATERMAIN, WATER SERVICES, OR STORM SEWER WHICH IS DAMAGED BY THE CONTRACTOR DURING HIS OPERATIONS SHALL BE REPAIRED TO THE OWNER'S SATISFACTION, AND AT THE CONTRACTOR'S EXPENSE.

GENERAL NOTES:

I. ALL WORK SHALL CONFORM TO ALL LOCAL, STATE, AND FEDERAL LAMS, RULES AND REGULATIONS IN FORCE AT THE TIME OF CONSTRUCTION.

2. DIMENSIONS TAKE PRECEDENCE OVER SCALE. CONTRACTOR TO VERIFY ALL DIMENSIONS IN FIELD.

3. IF ANY ERRORS, DISCREPANCIES, OR OMISSIONS BECOME APPARENT, THESE SHALL BE BROUGHT TO THE ATTENTION OF THE ARCHITECT PRIOR TO CONSTRUCTION OF ANYTHING AFFECTED, SO THAT CLARIFICATION OR REDESIGN MAY OCCUR.

4. ARCHITECTURAL WORK SHALL BE ACCORDING TO THE BOCA BUILDING CODE

5. ELECTRICAL WORK SHALL BE PERFORMED BY STATE OF MICHIGAN LICENSED ELECTRICIANS ACCORDING TO THE N.F.P.A. NATIONAL ELECTRICAL CODE AS MODIFIED BY THE STATE OF MICHIGAN, FURNISH AND INSTALL ALL MATERIALS AND LABOR TO PROVIDE A FULL WORKING ELECTRICAL SYSTEM.

6. ALL PLUMBING WORK SHALL BE PERFORMED BY STATE OF MICHIGAN LICENSED PLUMBERS ACCORDING TO THE BOCA PLUMBING CODE AS MODIFIED BY THE STATE OF MICHIGAN, AND THE LOCAL HEALTH DEPARTMENT. FURNISH AND INSTALL

ALL MATERIALS AND LABOR TO PROVIDE A FULL WORKING PLUMBING SYSTEM AND SEPTIC SYSTEM. 7. HEATING AND AIR CONDITIONING SHALL ACCORDING TO BOCA MECHANICAL CODE AS MODIFIED BY THE STATE OF MICHIGAN AND THE MICHIGAN ENERGY CODE. FURNISH AND INSTALL ALL MATERIALS AND LABOR TO PROVIDE A FULL

8 INTERIOR CONCRETE SHALL BE 3,000 PSI AT 28 DAY CURE, TROWELED AND 3,500 PSI FOR EXTERIOR WORK BROOM FINISH. INTERIOR CONCRETE SHALL HAVE NATURAL AGGREGATE AND THE EXTERIOR CONCRETE SHALL HAVE LIMESTONE AGGREGATE AND AIR ENTRAINED, 4-6%.

9. CONCRETE TESTING-CONTRACTOR SHALL EMPLOY AN INDEPENDENT TESTING ENGINEER TO VERIFY THE SLUMP, AIR ENTRAINMENT, AND PROVIDE (3) CYLINDER SAMPLES FOR EACH DAY'S POUR, OR EACH 50°C, Y. OF CONCRETE, WHICHEVER

10. SOIL BEARING CAPACITY IS ASSUMED TO BE 2,500 PSF. FOOTING CONCRETE SHALL BE POURED TO THE DEPTH REQUIRED TO BEAR ON UNDISTURBED SOIL OR ON GRANULAR FILL COMPACTED TO 95% MODIFIED PROCTOR DENSITY. NOTIFY THE ARCHITECT IF THESE CONDITIONS ARE NOT PRESENT.

II. TESTING REQUIREMENTS (ALL CONTRACTORS) SOIL AND GRAVEL DENSITY TESTING- CONTRACTOR SHALL EMPLOY AN INDEPENDENT TESTING CONSULTANT TO VERIFY THE DENSITY OF ALL FILL EXCAVATION AS SPECIFIED, AND ALL SLAB, FOUNDATIONS AND FOOTING BEARING SURFACES AS RECOMMENDED BY ENGINEER.

PLYWOOD:

MORKING HVAC SYSTEM.

WALL AND ROOF SHEATHING-APA OSB RATED SHEATHING, EXPOSURE 32/16, 7/16" PANELS

SUB FLOOR-APA RATED SHEATHING, EXPOSURE I 48/24 3/4" TONGUE AND GROOVE PLYWOOD

GENERAL NOTES:

ALL DOOR AND MINDOW HEADERS TO BE (2) 2" X 12" (UNLESS OTHERWISE CALLED FOR) PROVIDE DOUBLE CRIPPLES FOR ALL SPANS OVER 6'-O".

FRAMING LUMBER:

JOISTS & RAFTERS:

#I SOUTHERN YELLOW PINE, SURFACE DRIED fb=1,450 PSI (SINGLE)

E=1,700,000 PSI

DOUGLAS FIR NORTH, SURFACE DRIED

fb=800 PSI E=1,500,00 PSI

LAMINATED BEAMS:

FOR BEAMS IS INCHES AND LESS IN DEPTH: fb= 2,000 PSI E=1,500,000 PSI

FOR BEAMS 15 1/2 INCHES, AND GREATER IN DEPTH. Pb=2,400 PSI E=1,700,000 PSI


8-4-95 ISSUED FOR BID PURPOSES ONLY


7-18-45 ISSUED FOR CLIENT REVIEW AND COMMENT CASS DISTRICT LIBRARY, EDWARDSBURG CHURCH STREET, EDWARDSBURG, MICHIGAN


MAWN BY DLG AS NOTED MAR., 1995


-WIGHTMAN & ASSOCIATES, INC. 920 BROAD STREET, ST. JOSEPH, MICHIGAN DRAWING NUMBER SITE PLAN, NOTES, GENERAL NOTES


X-3279-1

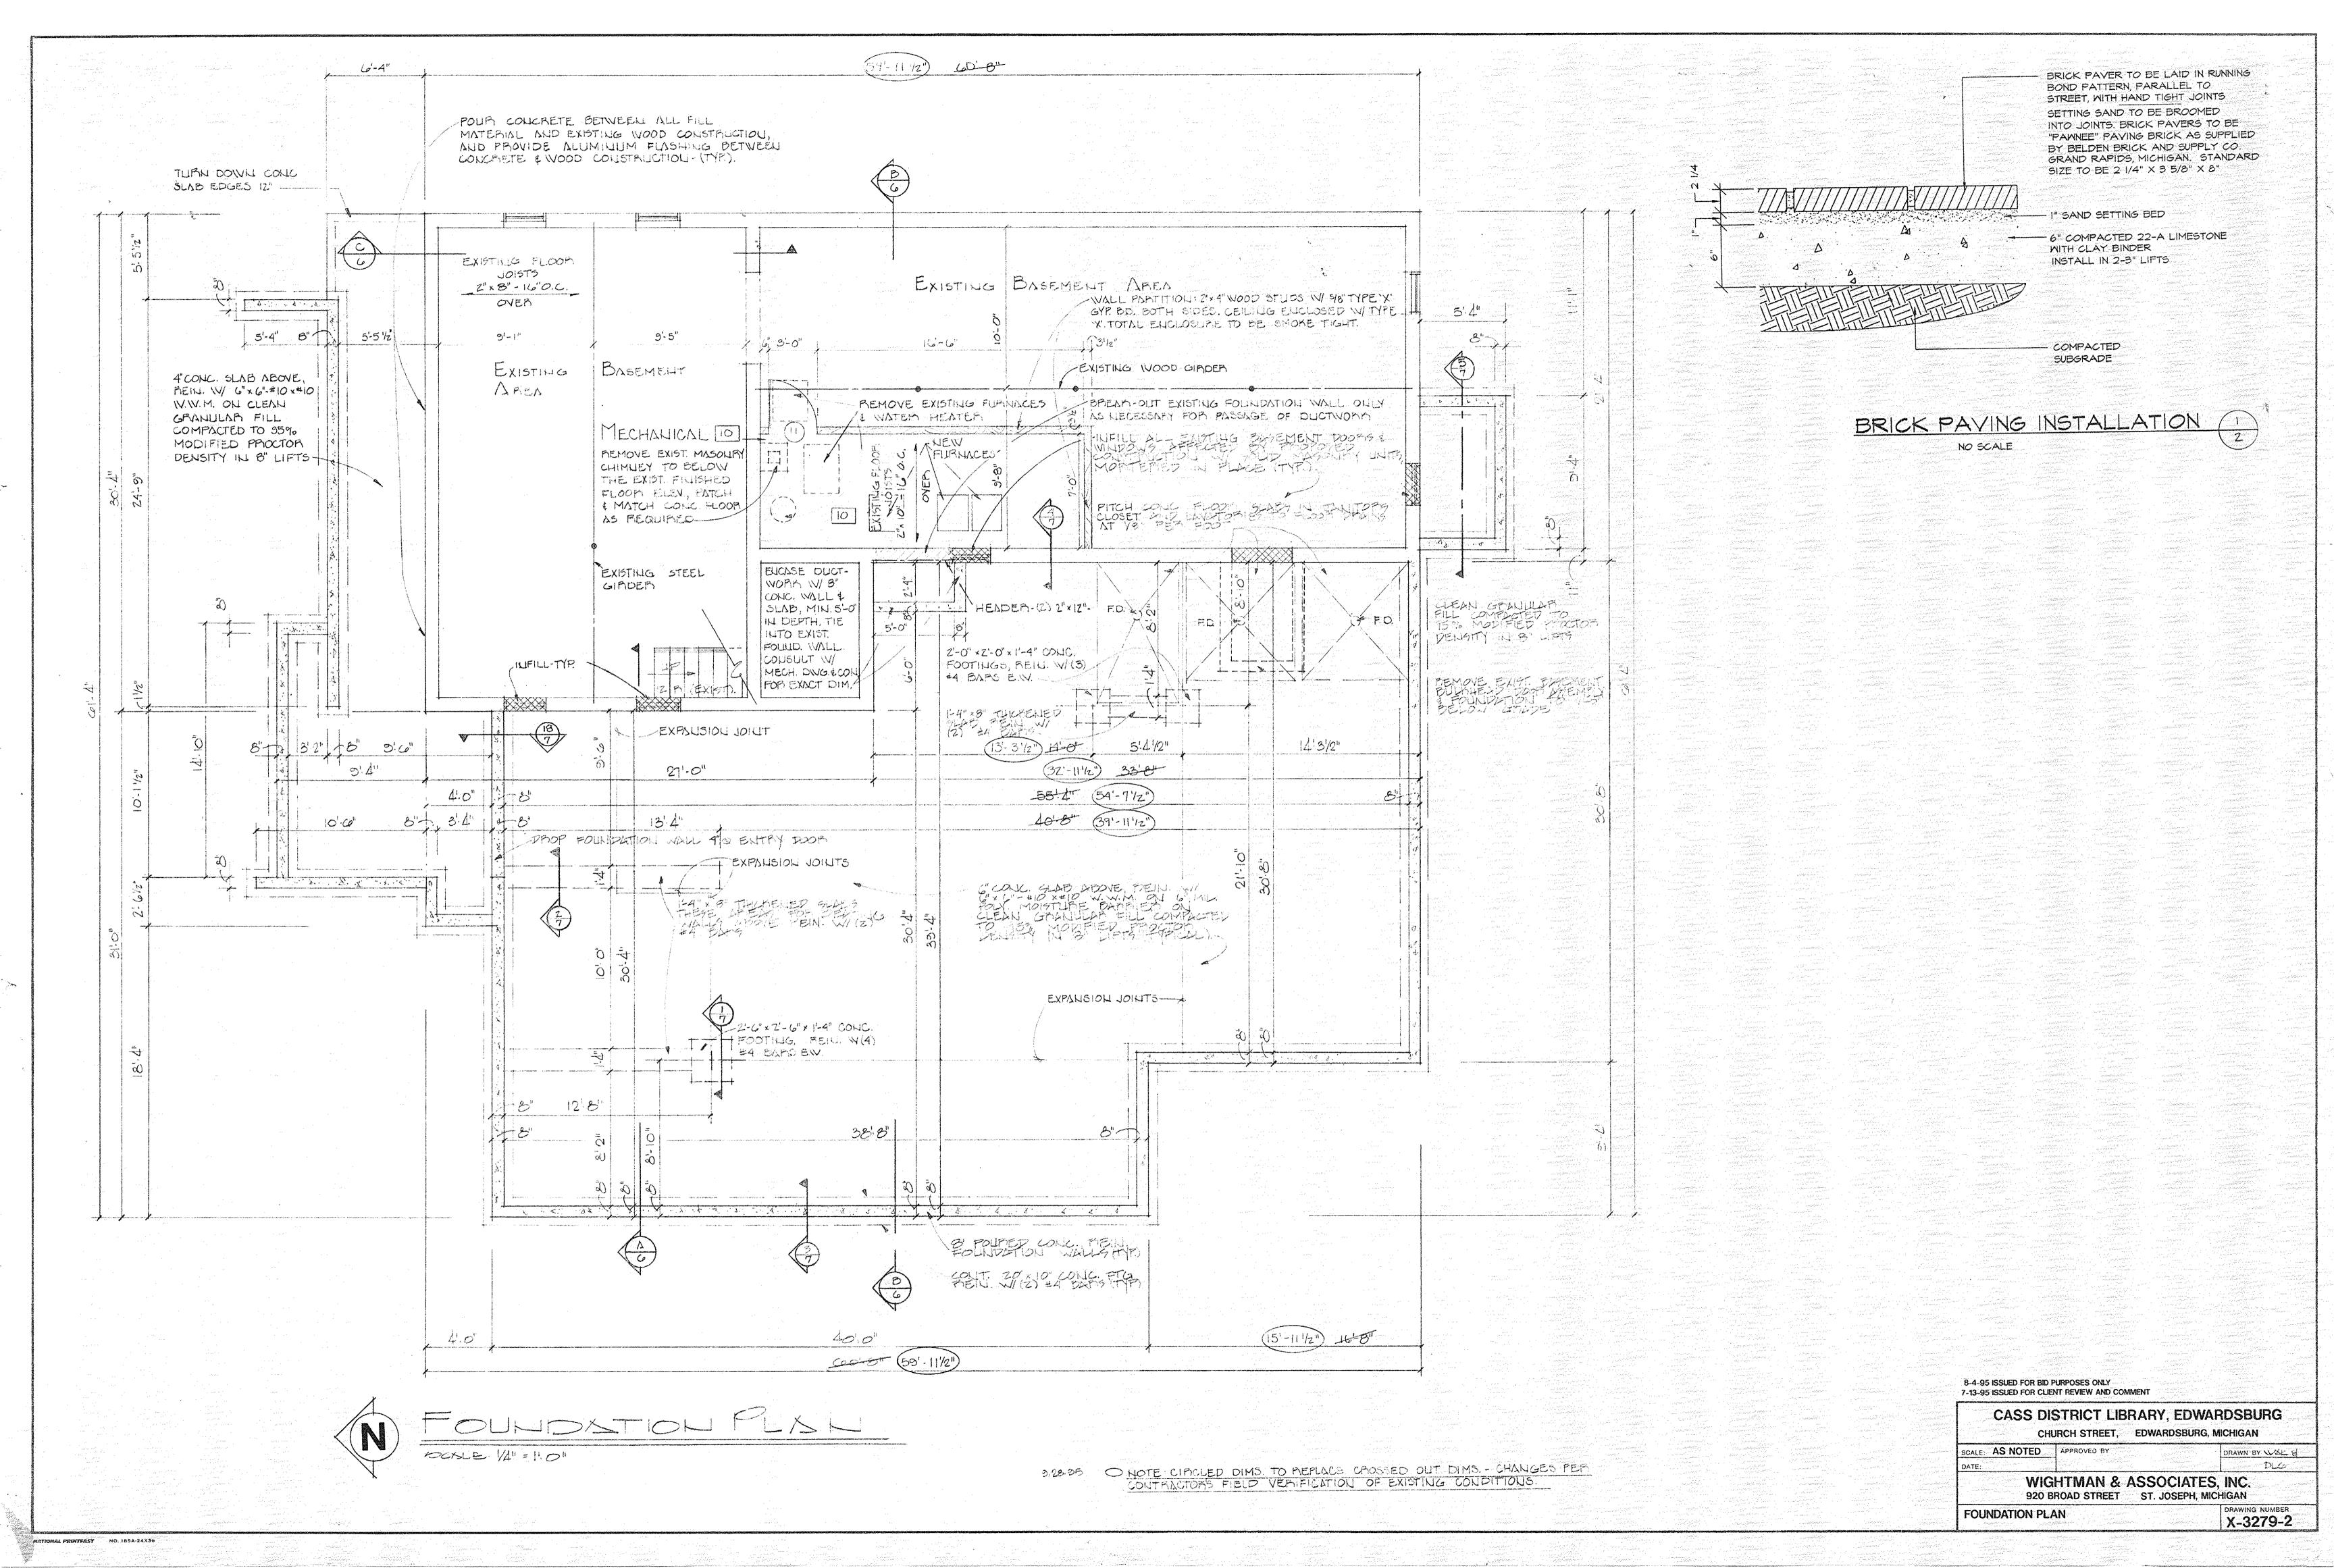


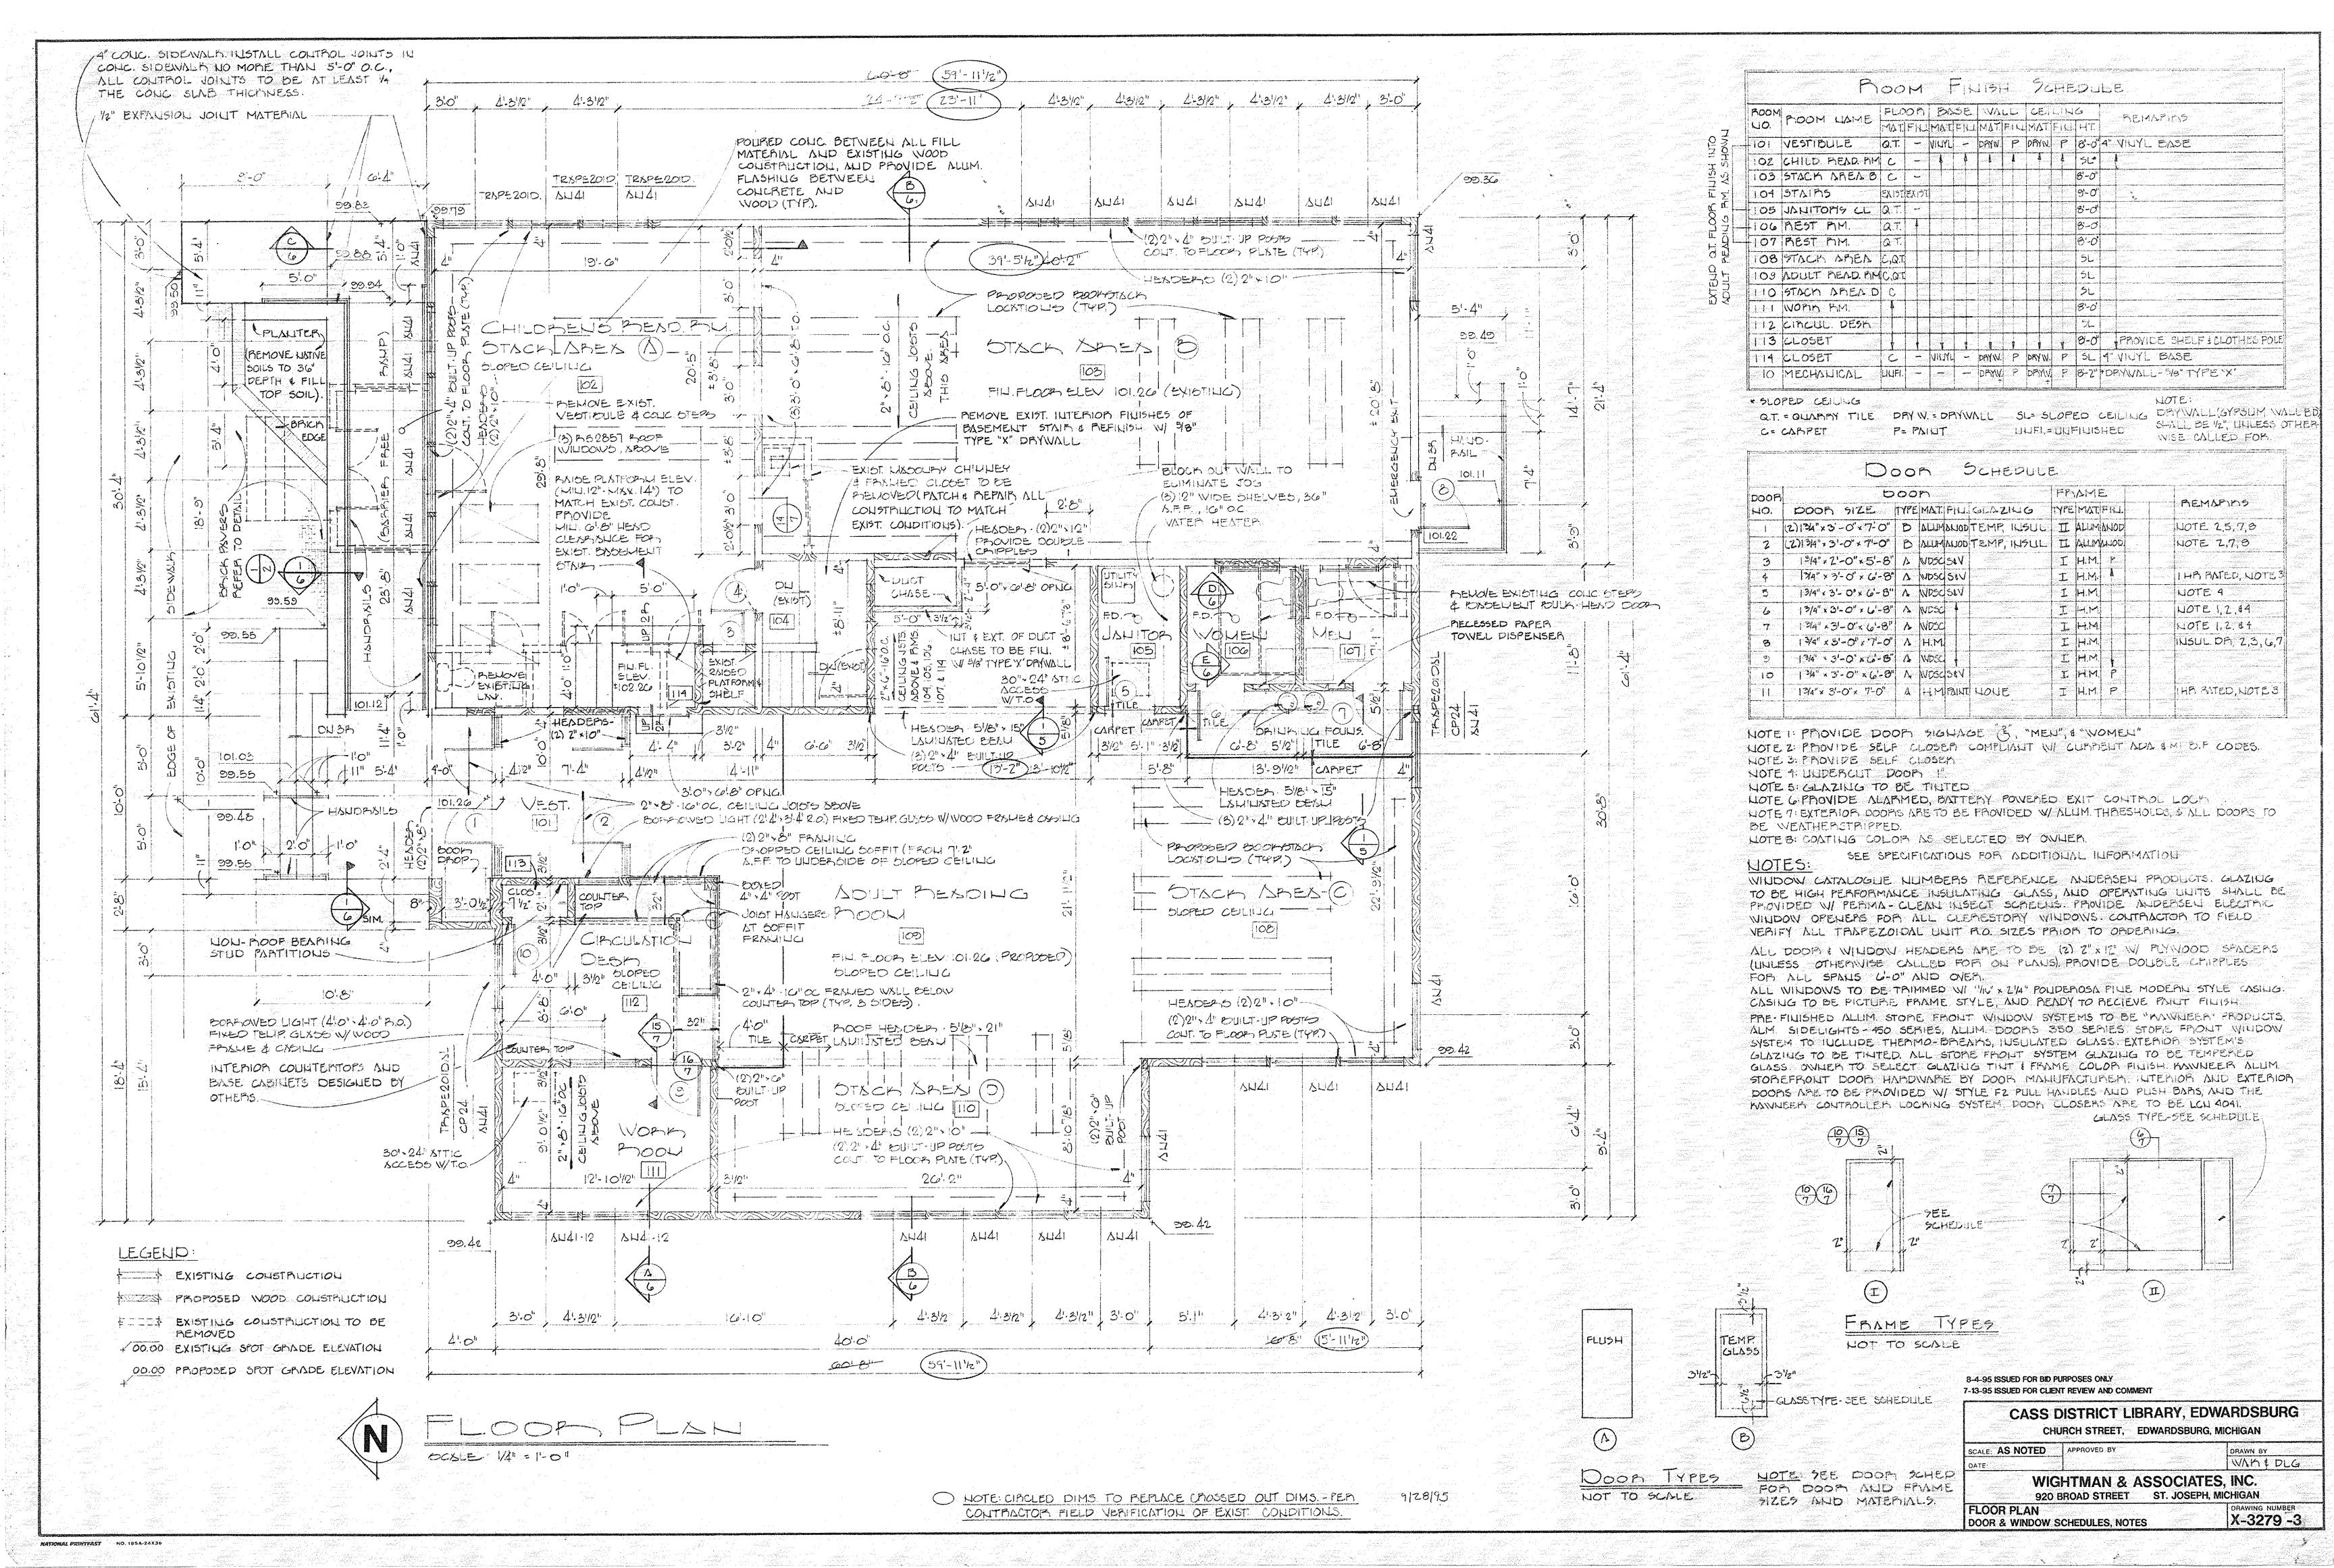


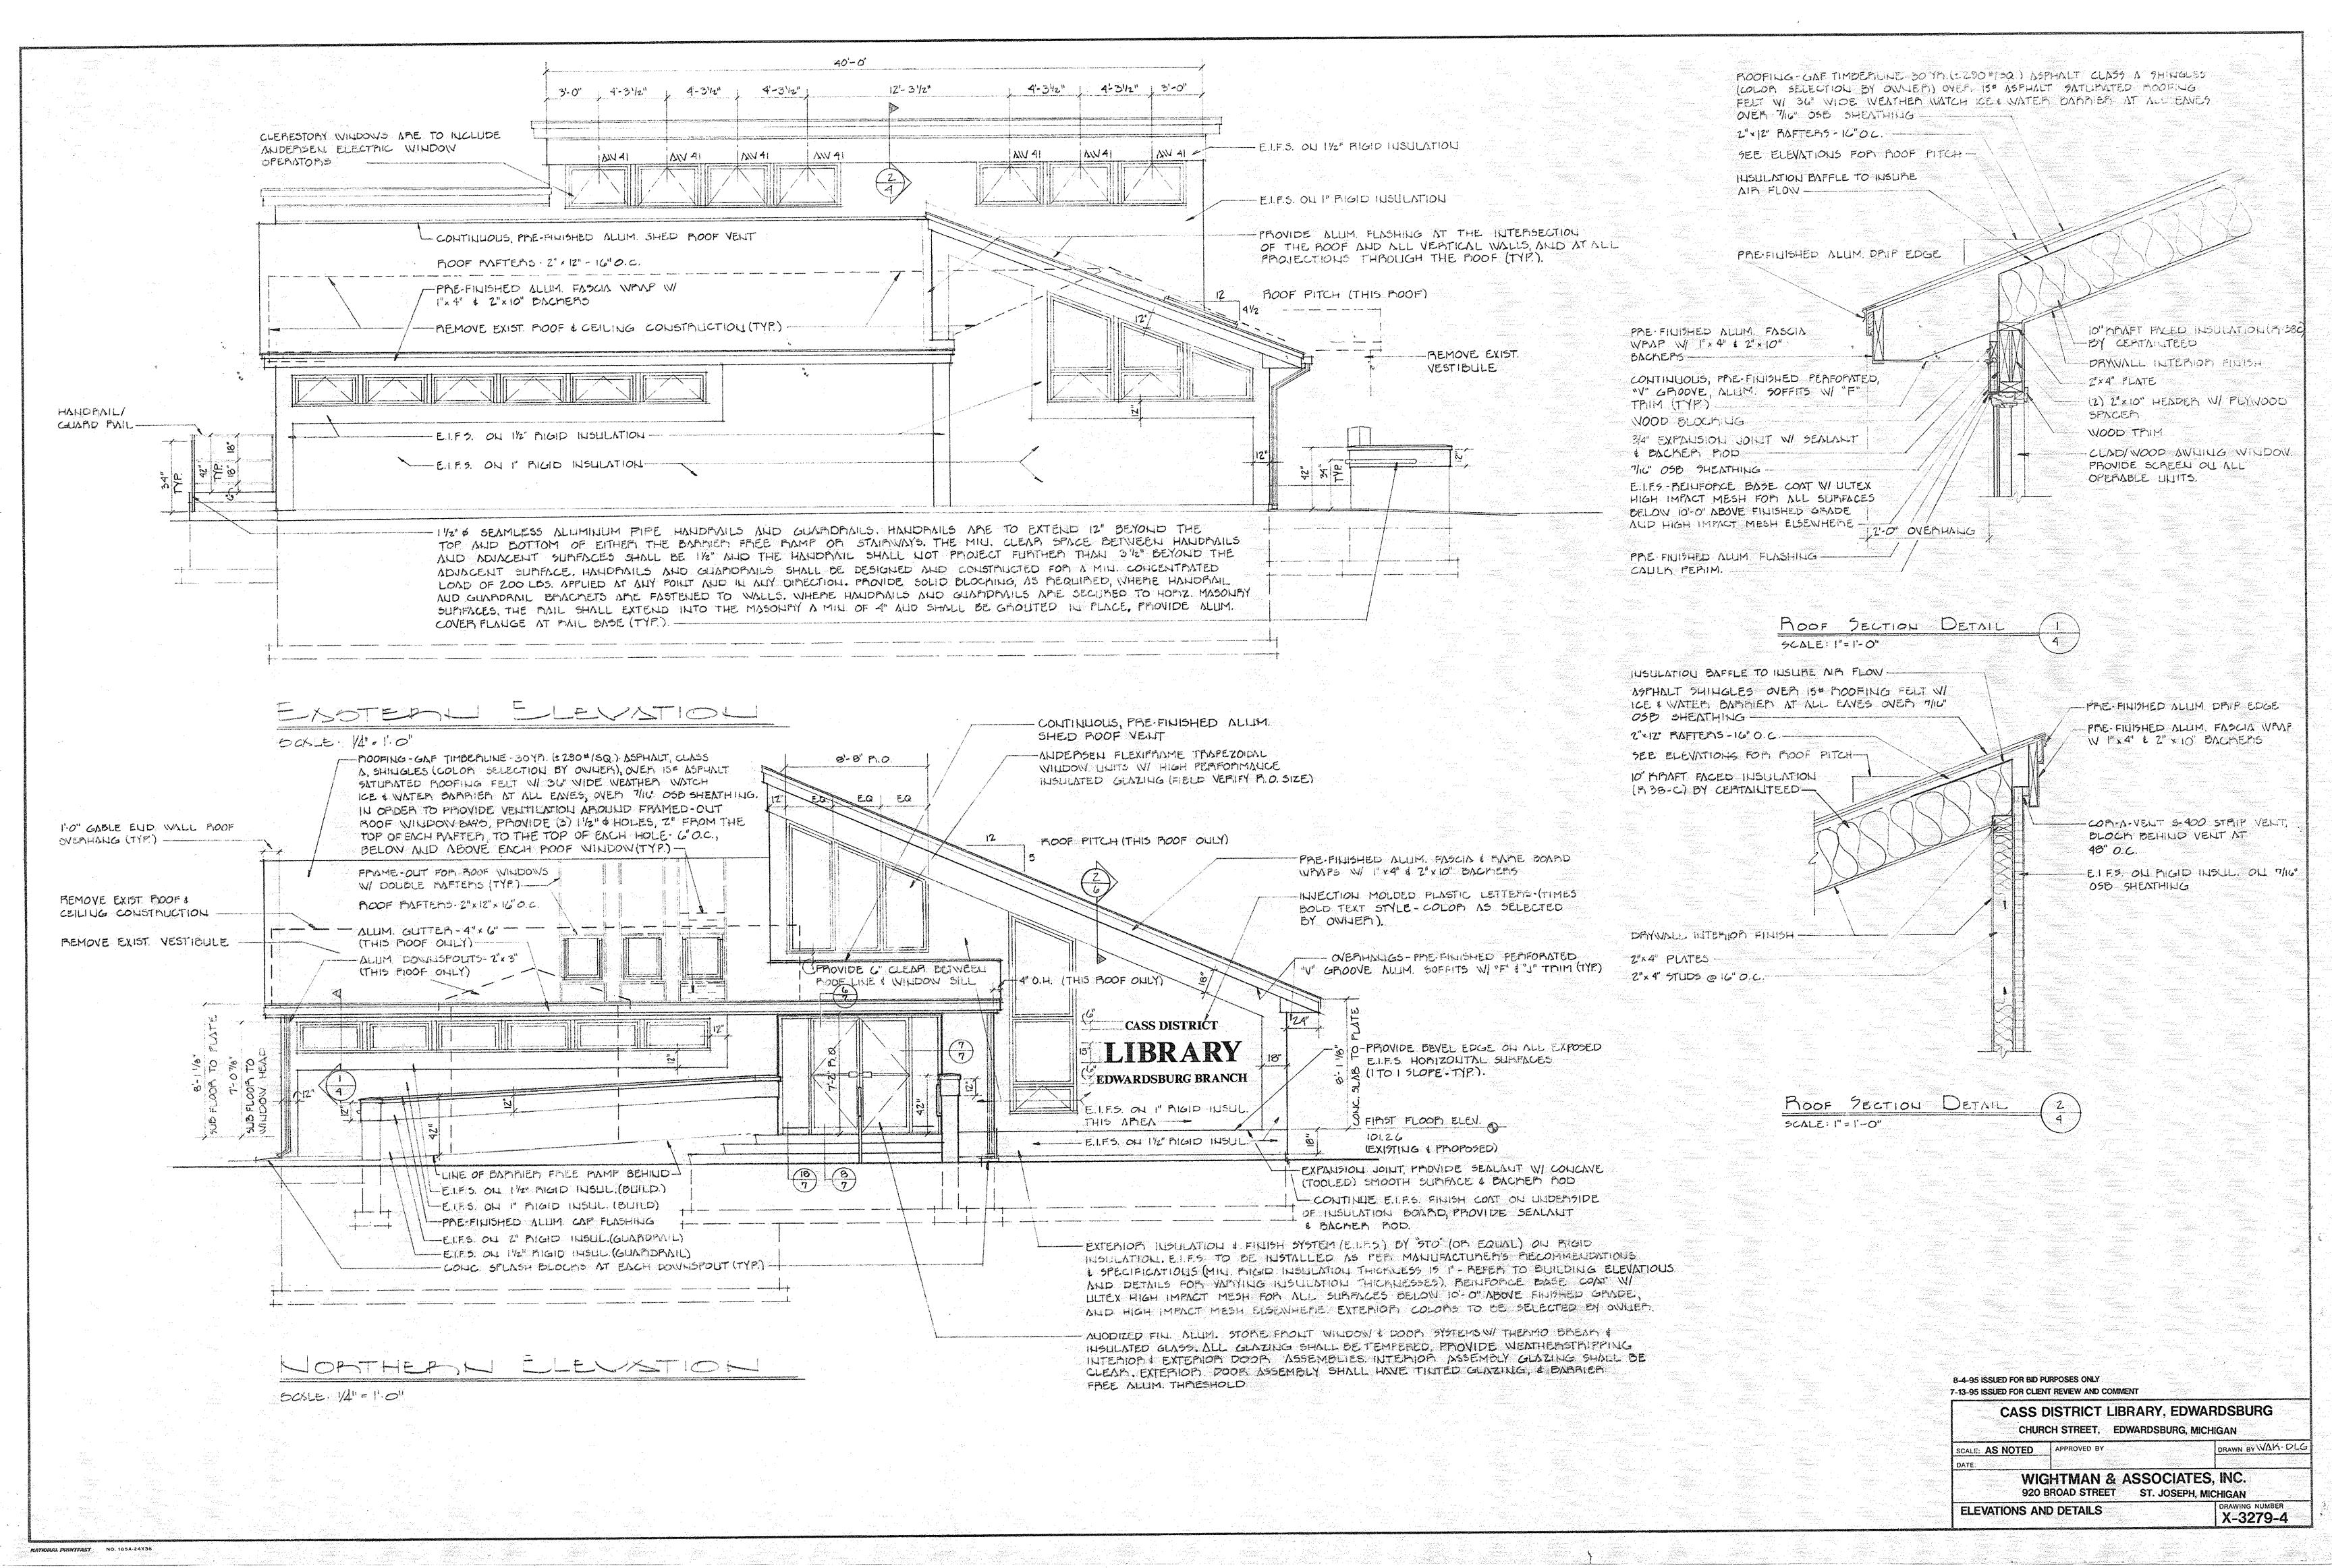

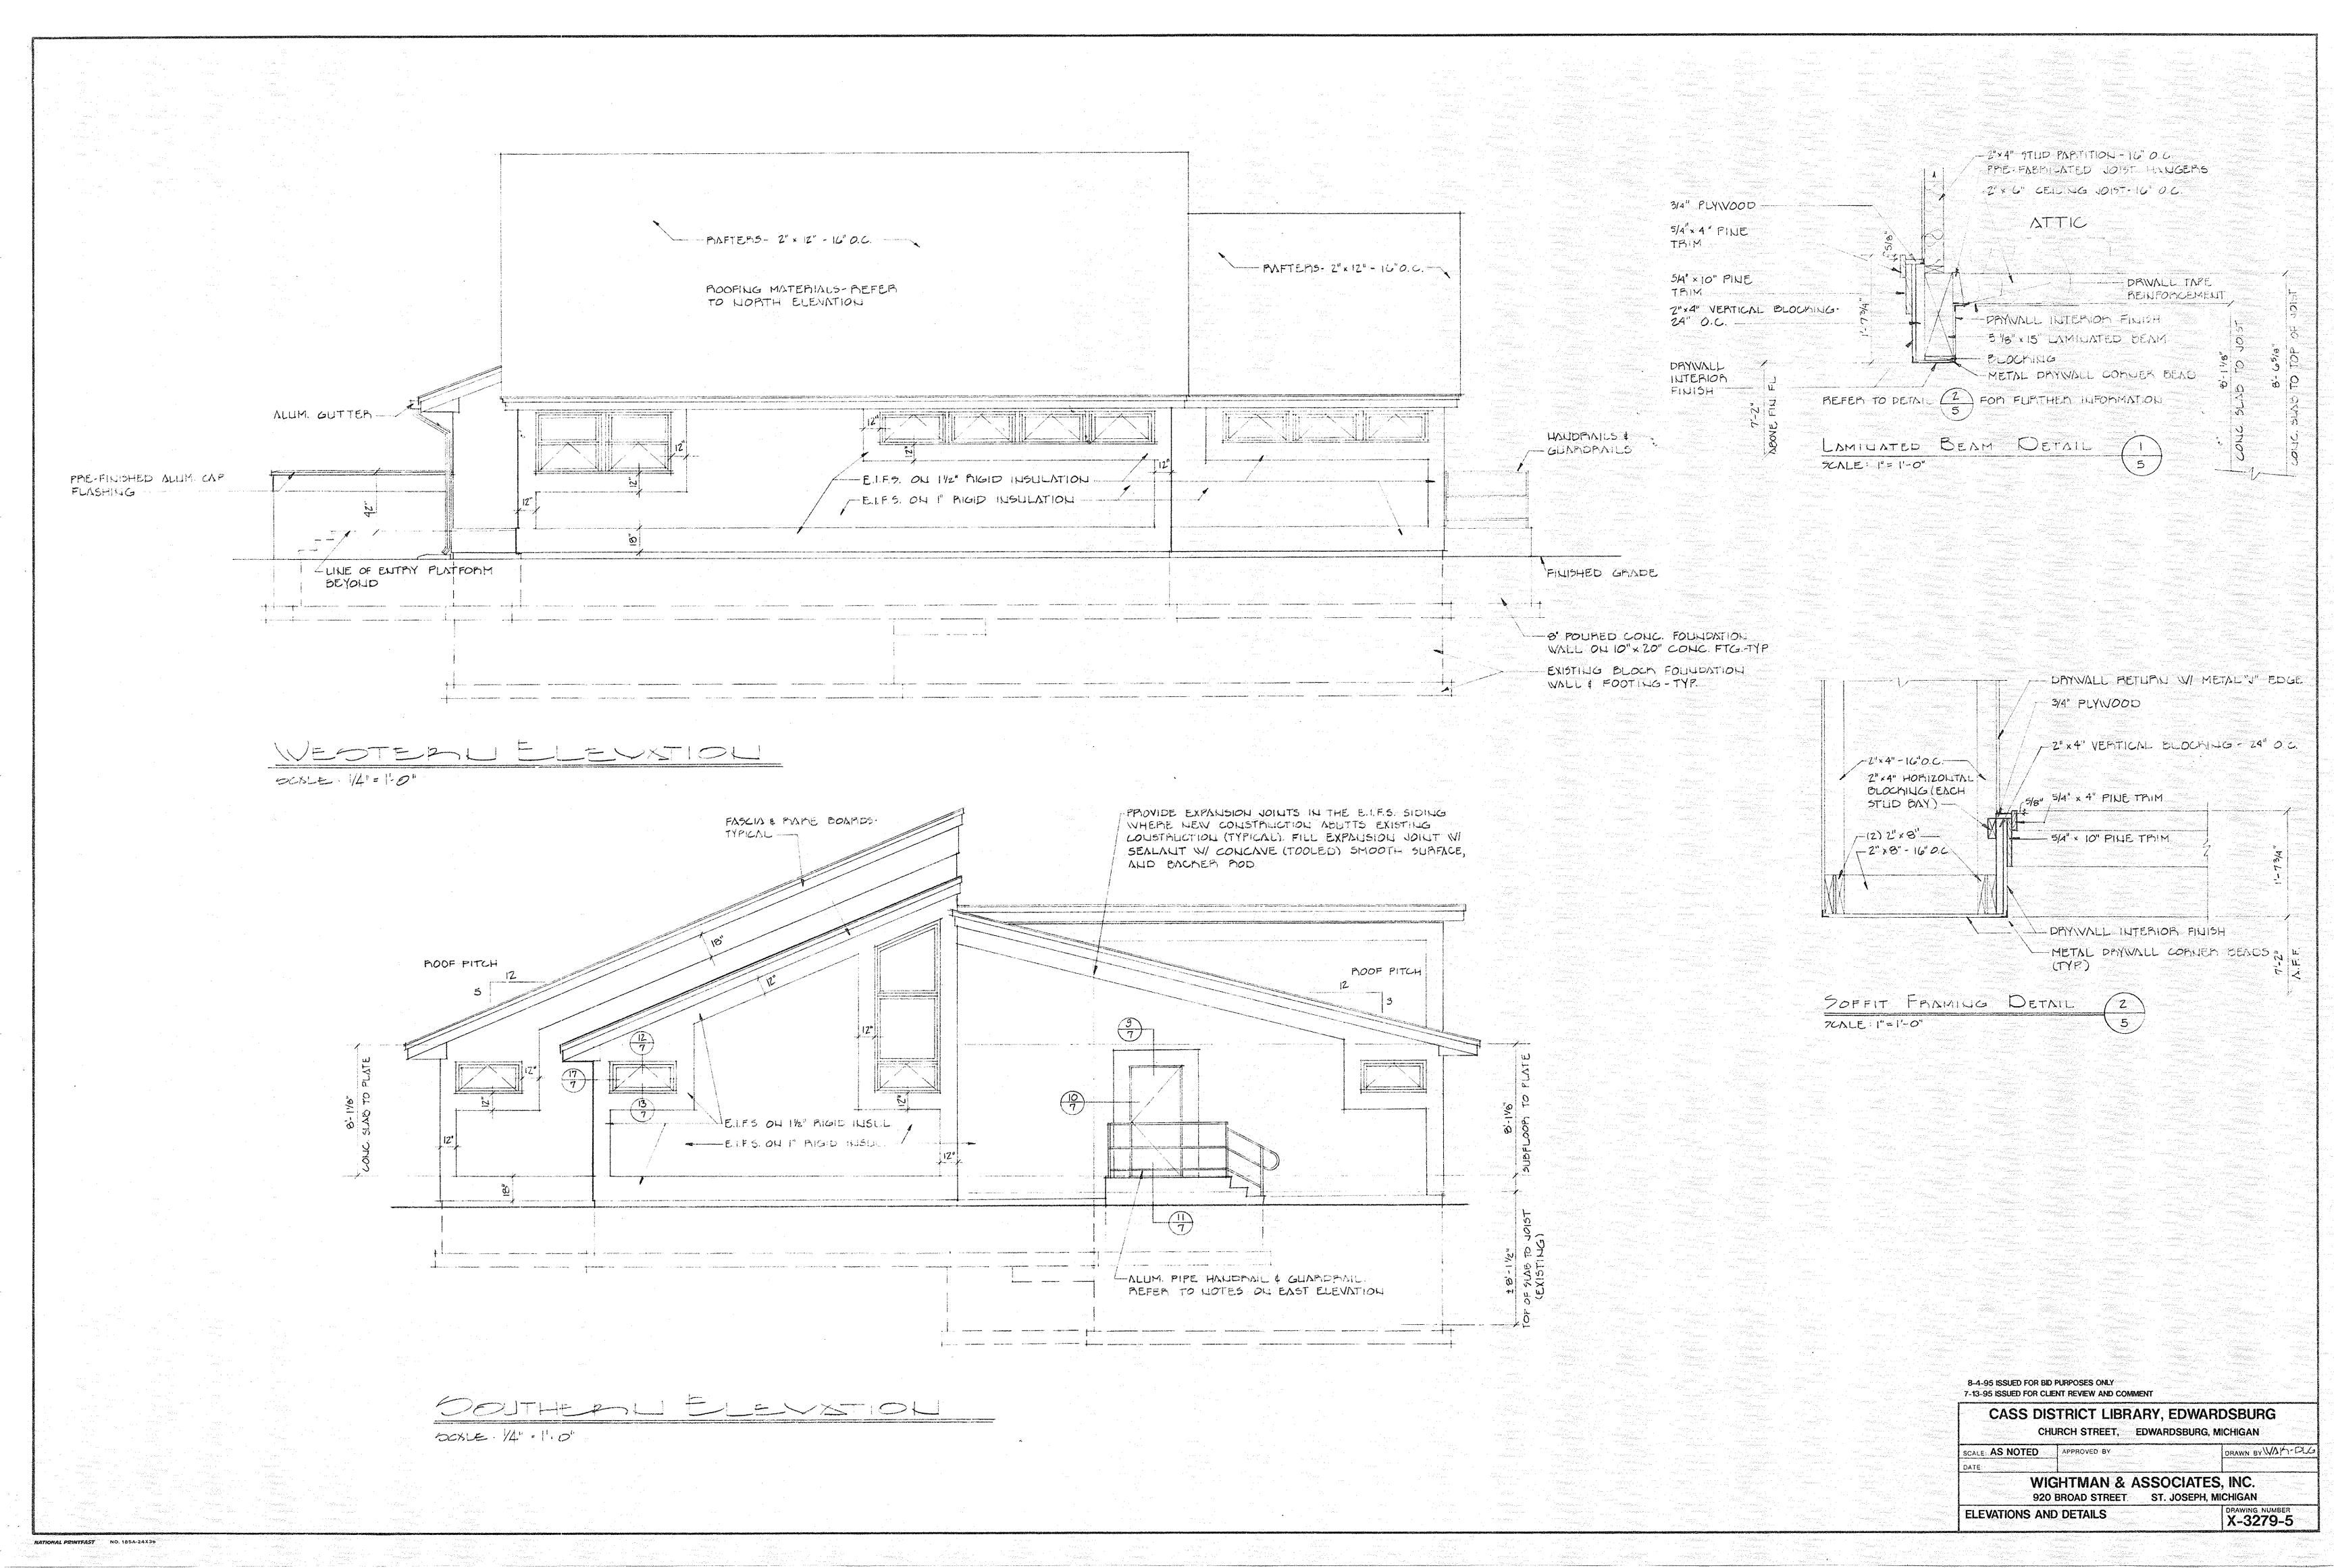

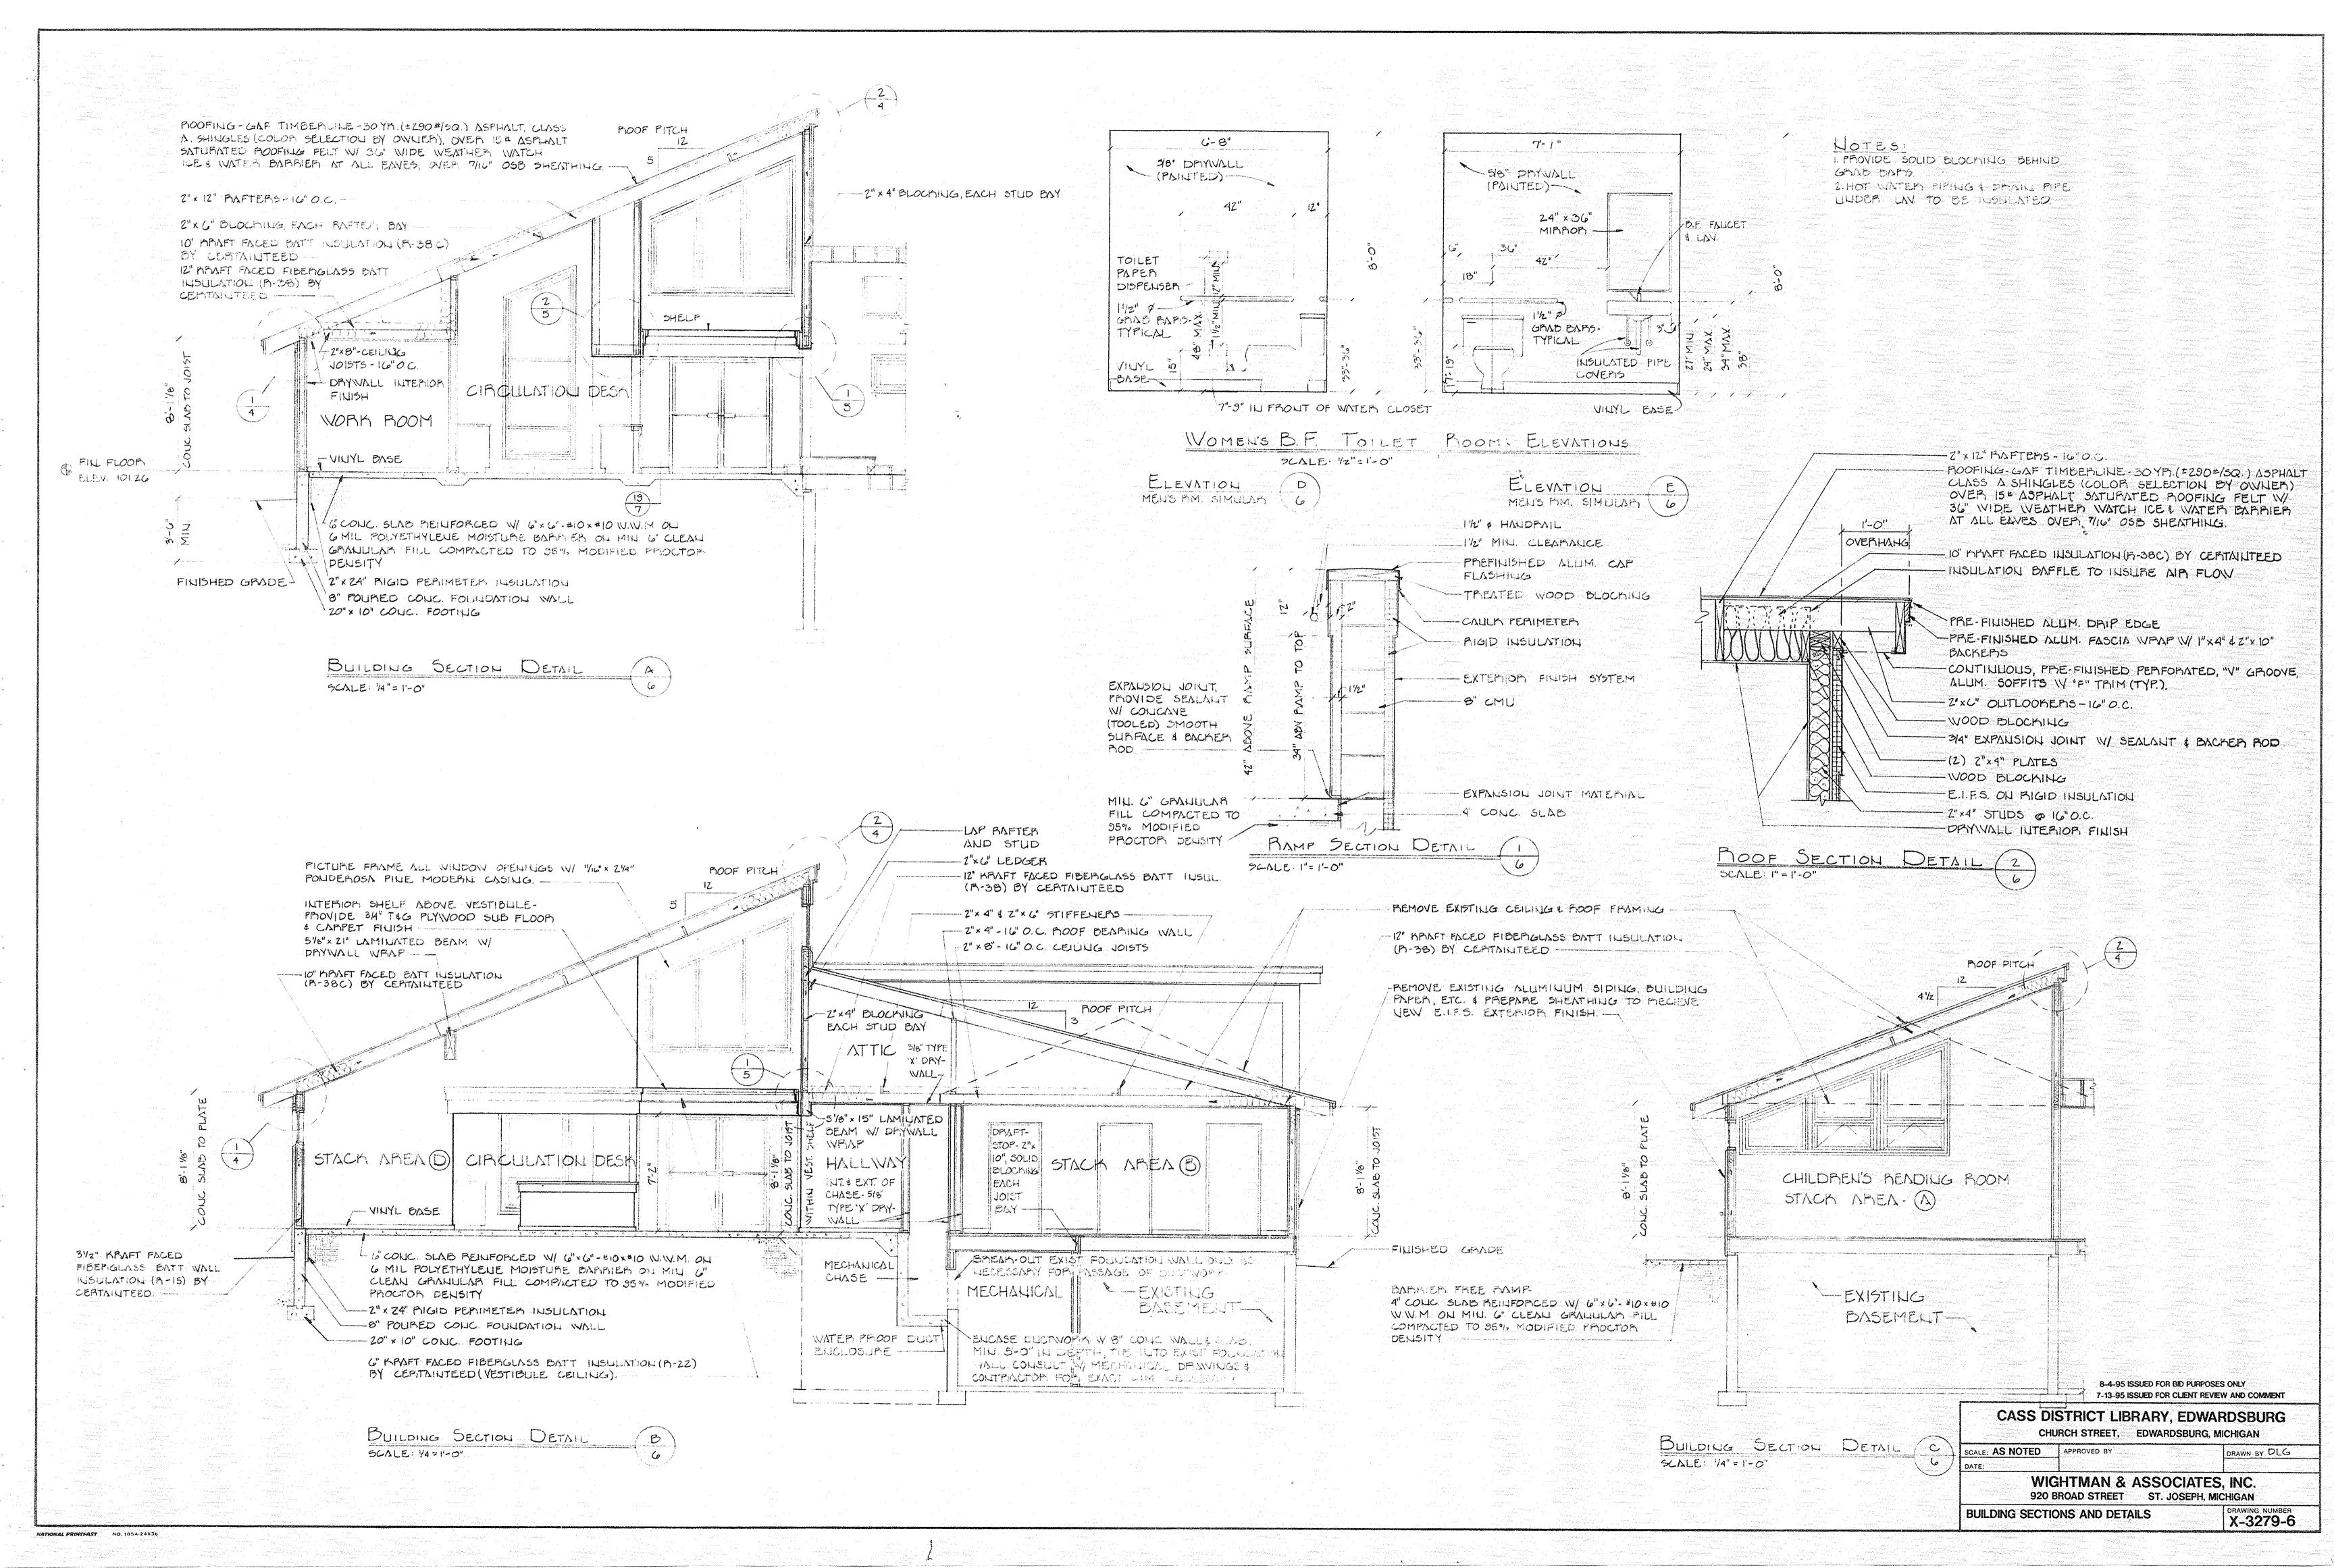

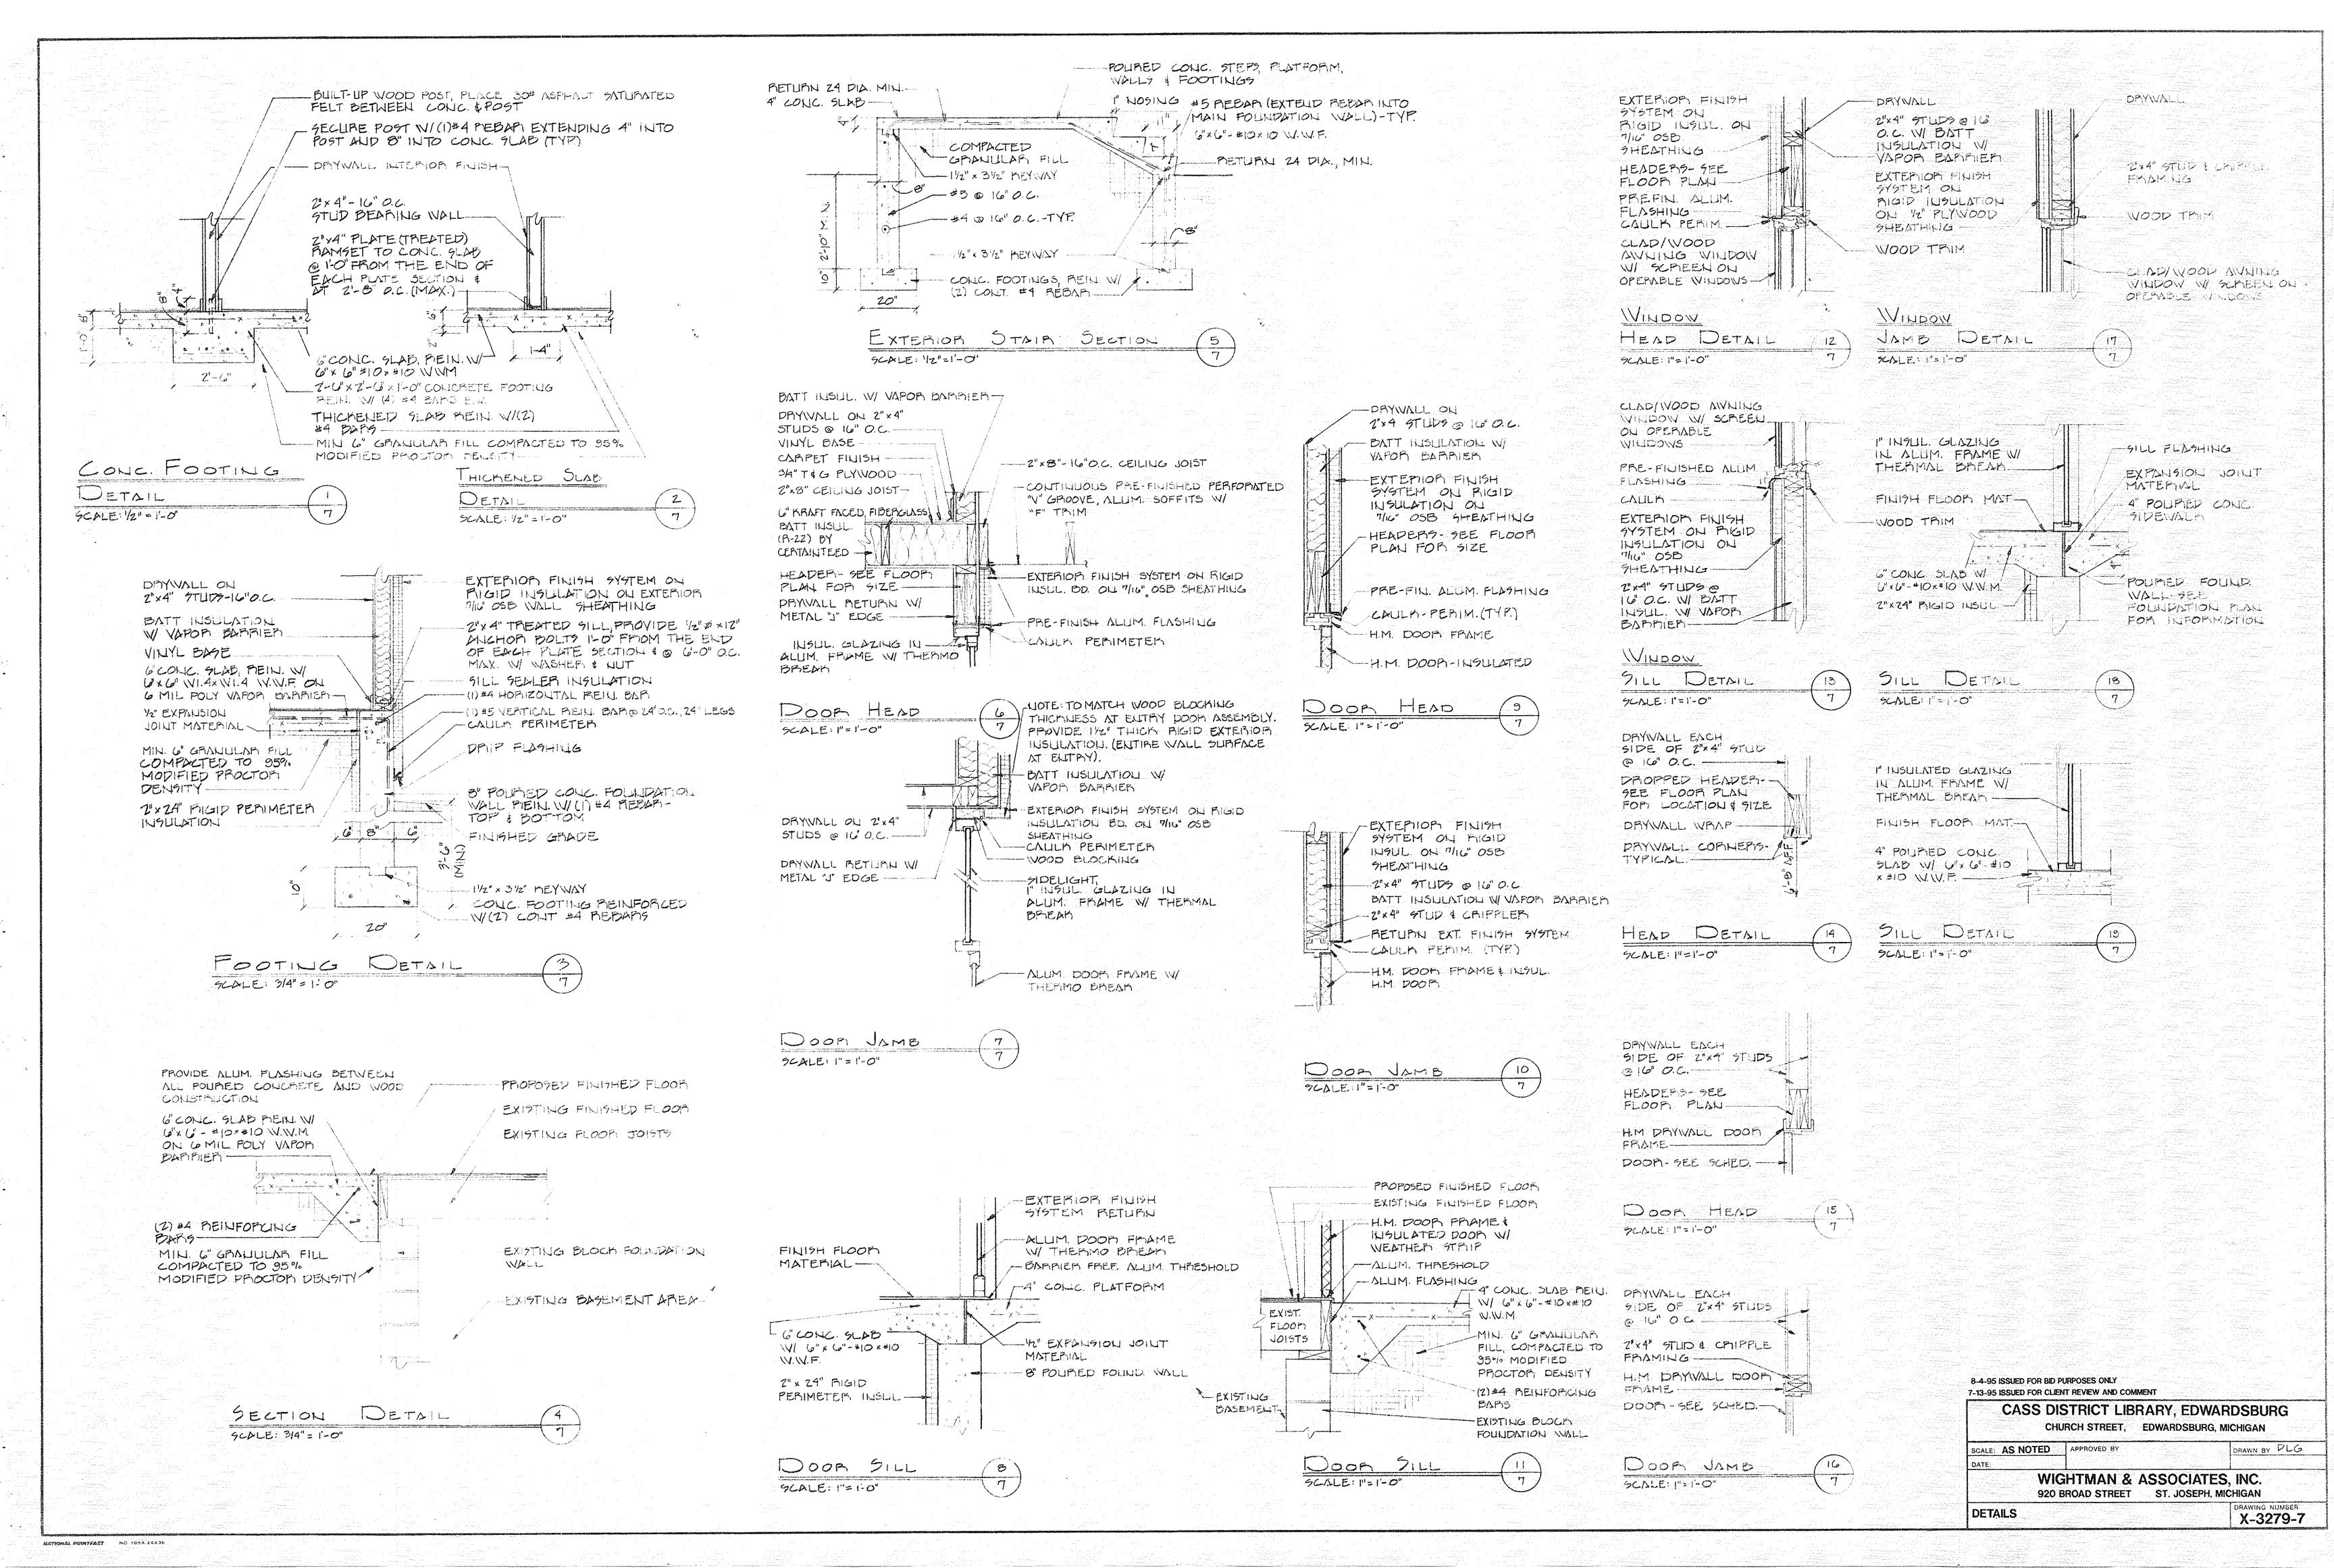

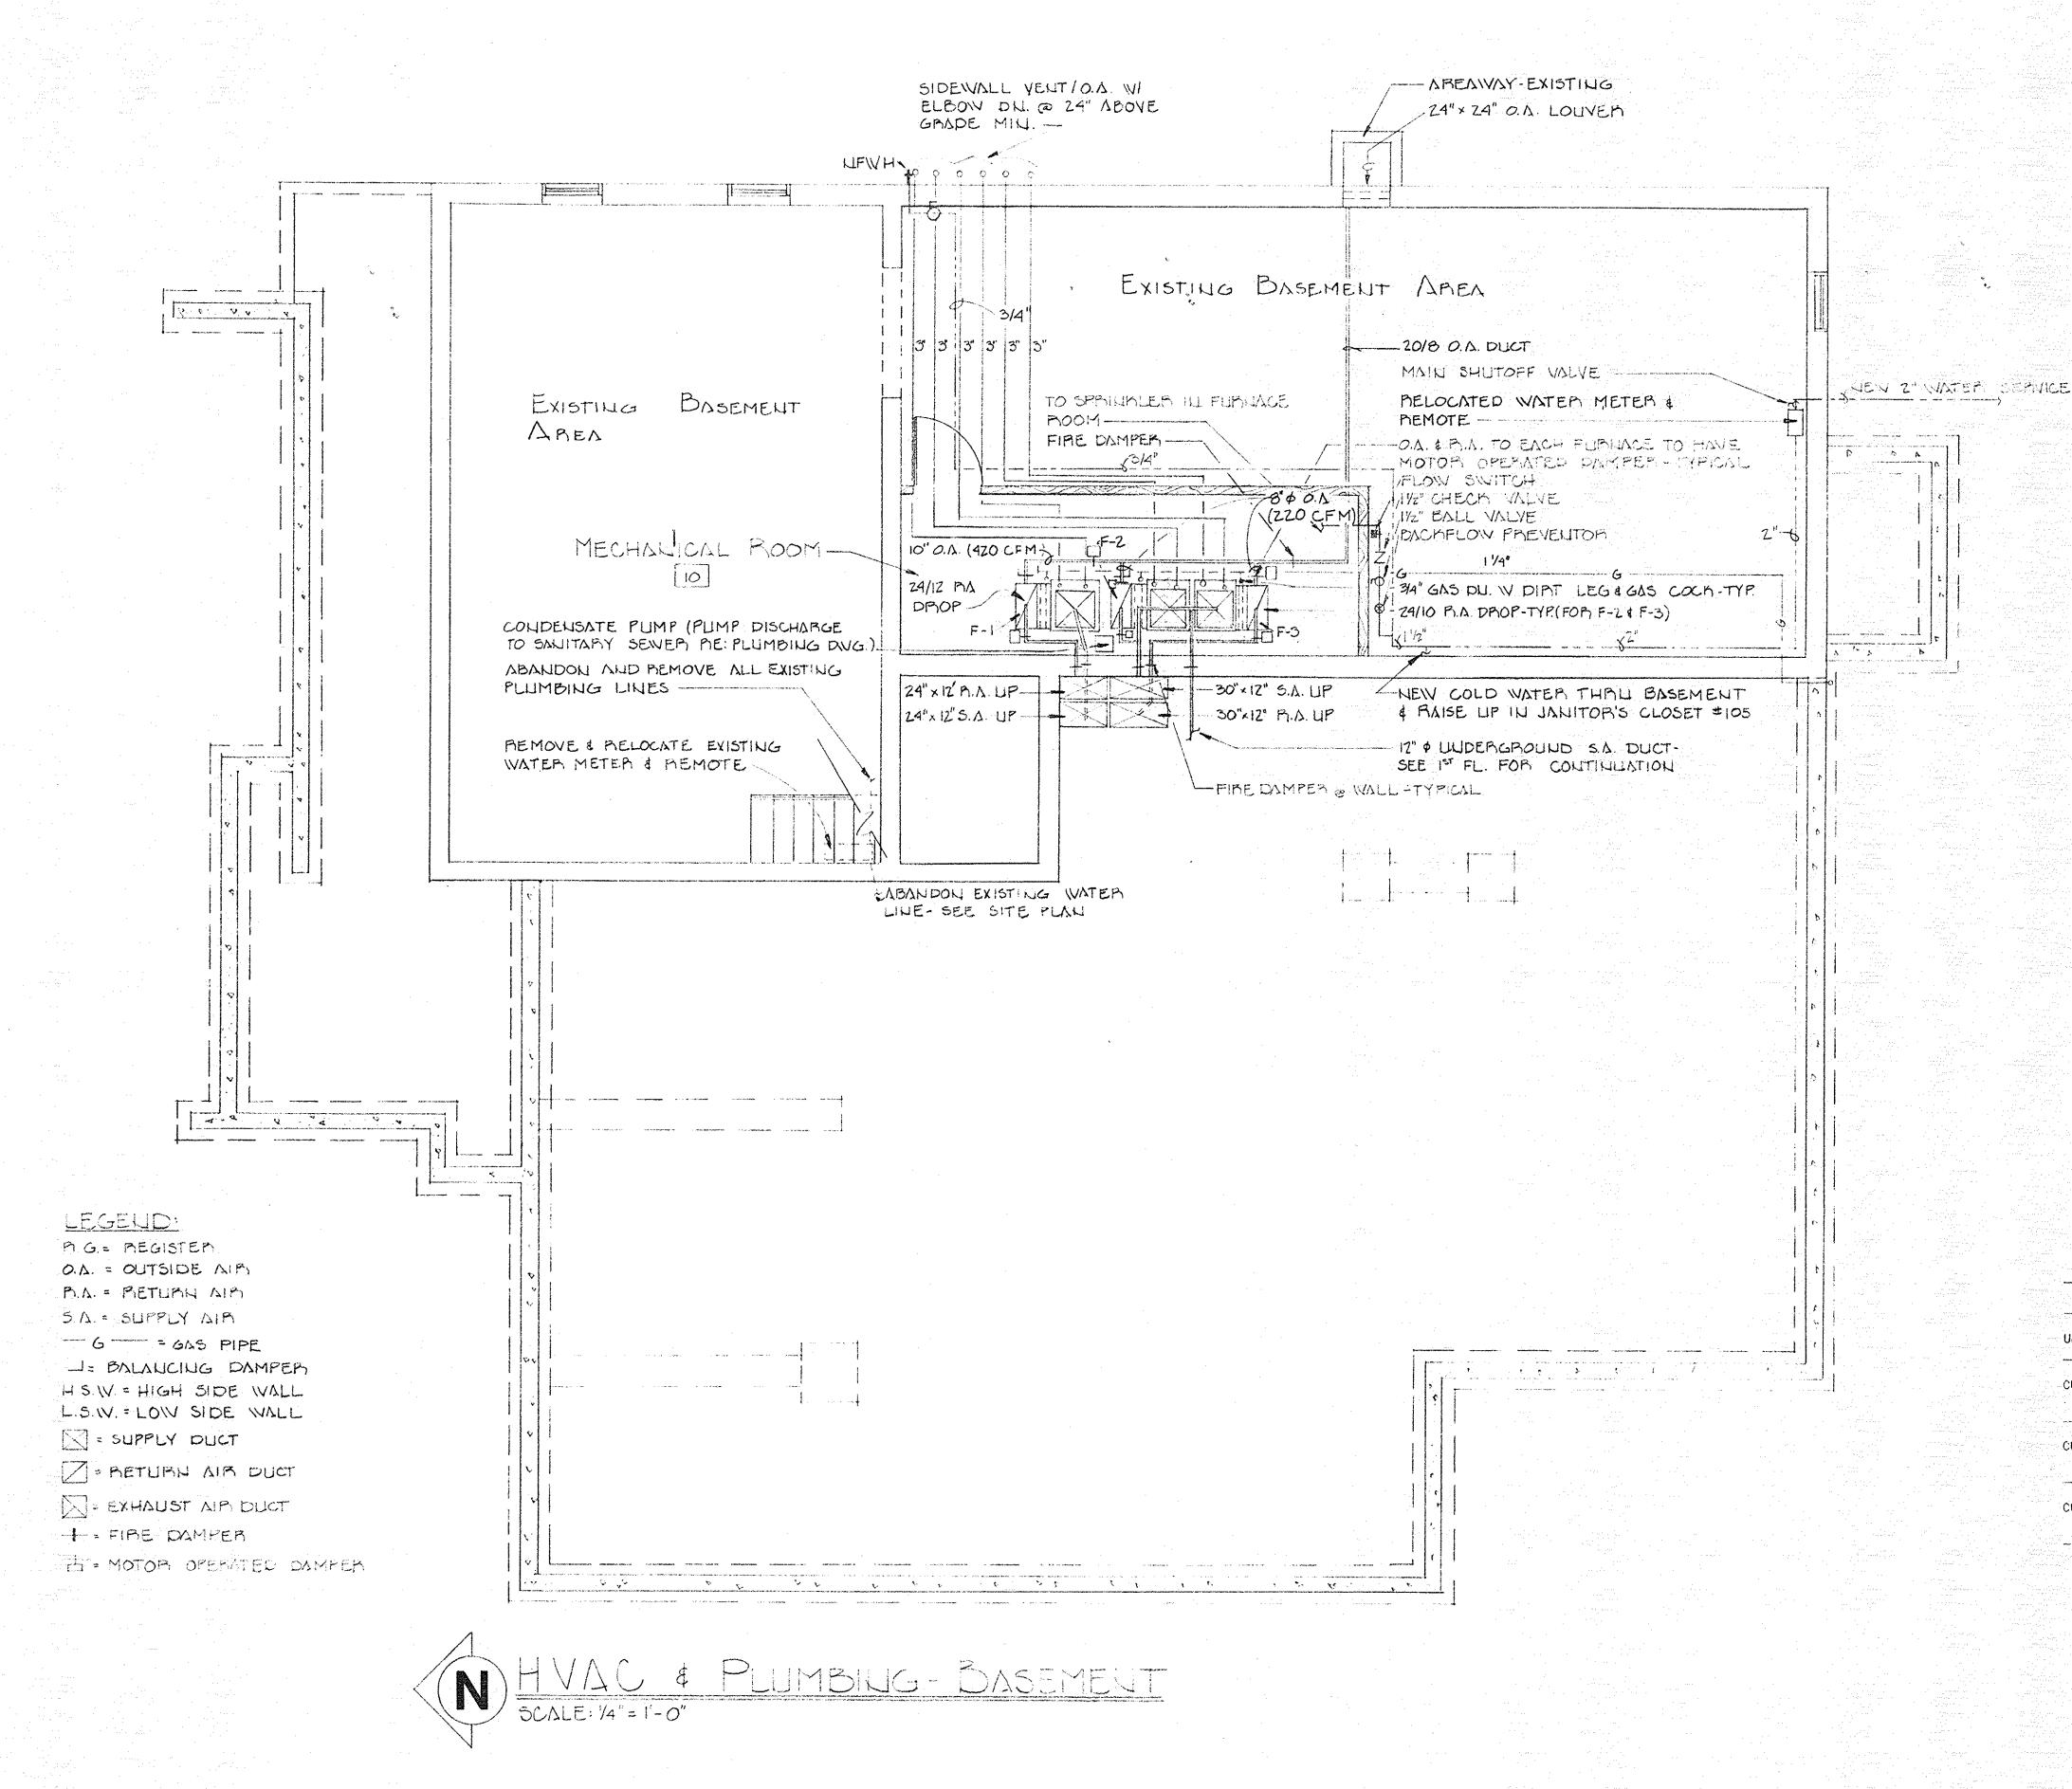

SPRINKLER NOTES

- 1. THE FIRE PROTECTION SYSTEM (SPRINKLERS) FOR MECHANICAL ROOM 10 SHALL CONFORM TO NFPA 13 SPECIFICATIONS.
- THE SPRINKLER CONTRACTOR SHALL INSTALL A WET PIPE SPRINKLER SYSTEM IN MECHANICAL ROOM 10.
- 3. SPRINKLER CONTRACTOR SHALL INCLUDE ALL ELECTRICAL WIRING REQUIRED FROM MAIN PANEL TO ALL FLOW SWITCHES, ALARMS, ETC. AS MAY BE REQUIRED BY GOVERNING RULES AND REGULATIONS.
- 4. SPRINKLER CONTRACTOR SHALL PROVIDE ALL ADDITIONAL DRAWINGS, SPECIFICATIONS AND CALCULATIONS AS MAY BE REQUIRED BY GOVERNING RULES AND REGULATIONS. ALL WORK SHALL BE DESIGNED, SEALED, AND SIGNED BY A REGISTERED ENGINEER.
- SPRINKLER CONTRACTOR SHALL OBTAIN AND PAY FOR ALL STATE AND LOCAL PERMITS REQUIRED FOR HIS WORK, AND SCHEDULE ANY INSPECTIONS REQUIRED BY GOVERNING RULES AND REGULATIONS.
- 6. SPRINKLER CONTRACTOR SHALL COORDINATE TESTING WITH GENERAL CONTRACTOR.
- SEE SPECIFICATIONS FOR FURTHER INFORMATION AND QUALIFICATIONS.

	The Control of the Co
	PUMP SCHEDULE
	그는 것 같은 생님들이 가장 수밖에도 그것 같은 아름아가는 것 같은 사람들이 가장 하는 것 같은 사람들이 살아 없었다.
	CAPACITY
LOCATION TYPE DUTY	GPM HEAD FT. H.P. VOLTAGE RPM BASE MF'G CATALOG NO.
Mechanical Rm Condensate	.42 15 1/30 115/1/60 Little Giant #VCM-20UL
· · · · · · · · · · · · · · · · · · ·	,我们就是一个 那 都是我的,我也没有的,我就是这个的,我们就是一个人,我们就是一个人,我们就是一个人,我们就是一个人,我们就是这一个人,我们就是一个人,我们就不


				FURN	ACE SC	I E D U L		
NO.	MBH INPUT	MBH OUTPUT FU	EL C.F.M.	s.P. H.	P. VOLTAGE	MFG. 8	S CATALOG NO.	
F-1	100	92 N.	Gas 1759	.5 3/	/4 115/1/60	Trane	#TUX100C960A	
F-2	100	92 N.	Gas 1523	.5 3/	/4 115/1/60	Trane	#TUX100C948A	
F-3	100	92 N.	Gas 1523	.5 3/	/4 115/1/60	Trane	#TUX100C948A	

Provide programable thermostat for F-1.

Provide twinning kit for F-2, 3 and 2-stage heating and cooling programable thermostat.

Provide each furnace with side filter rack and cooling coil matched to condensing unit.

			CONDENS	ING UNIT	SCHEDULE	
UNIT NO.	COOLING CAP @ 95 AMBIENT	S.E.E.R.	SUCTIO E.E.R. TEMP.	N MOTOR COMPRESSOR	COND. FAN	REMARKS
CU-1	60.000	10.25		1 - 208/230/1/60 29.1 amp	1 - 208/230/1/60 1/4 H.P.	Trane #TTR060C100A
CU-2	46.000	10.0		1 - 208/230/1/60 24.0 amp	1 - 208/230/1/60 1/5 H.P.	Trane #TTR048C100A
CU-3	46.000	10.0		1 - 208/230/1/60 24.0 amp	1 - 208/230/1/60 1/5 H.P.	Trane #TTR048C100A

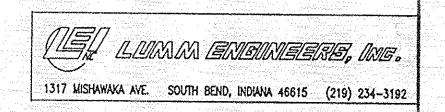

8-4-95 ISSUED FOR BID PURPOSES ONLY
7-13-95 ISSUED FOR CLIENT REVIEW AND COMMENT

CASS DISTRICT LIBRARY, EDWARDSBURG CHURCH STREET, EDWARDSBURG, MICHIGAN


WIGHTMAN & ASSOCIATES, INC.
920 BROAD STREET ST. JOSEPH, MICHIGAN


MECHANICAL & PLUMBING


SCALE: AS NOTED APPROVED BY

DRAWING NUMBER
X-3279- M1


DRAWN BY DLG

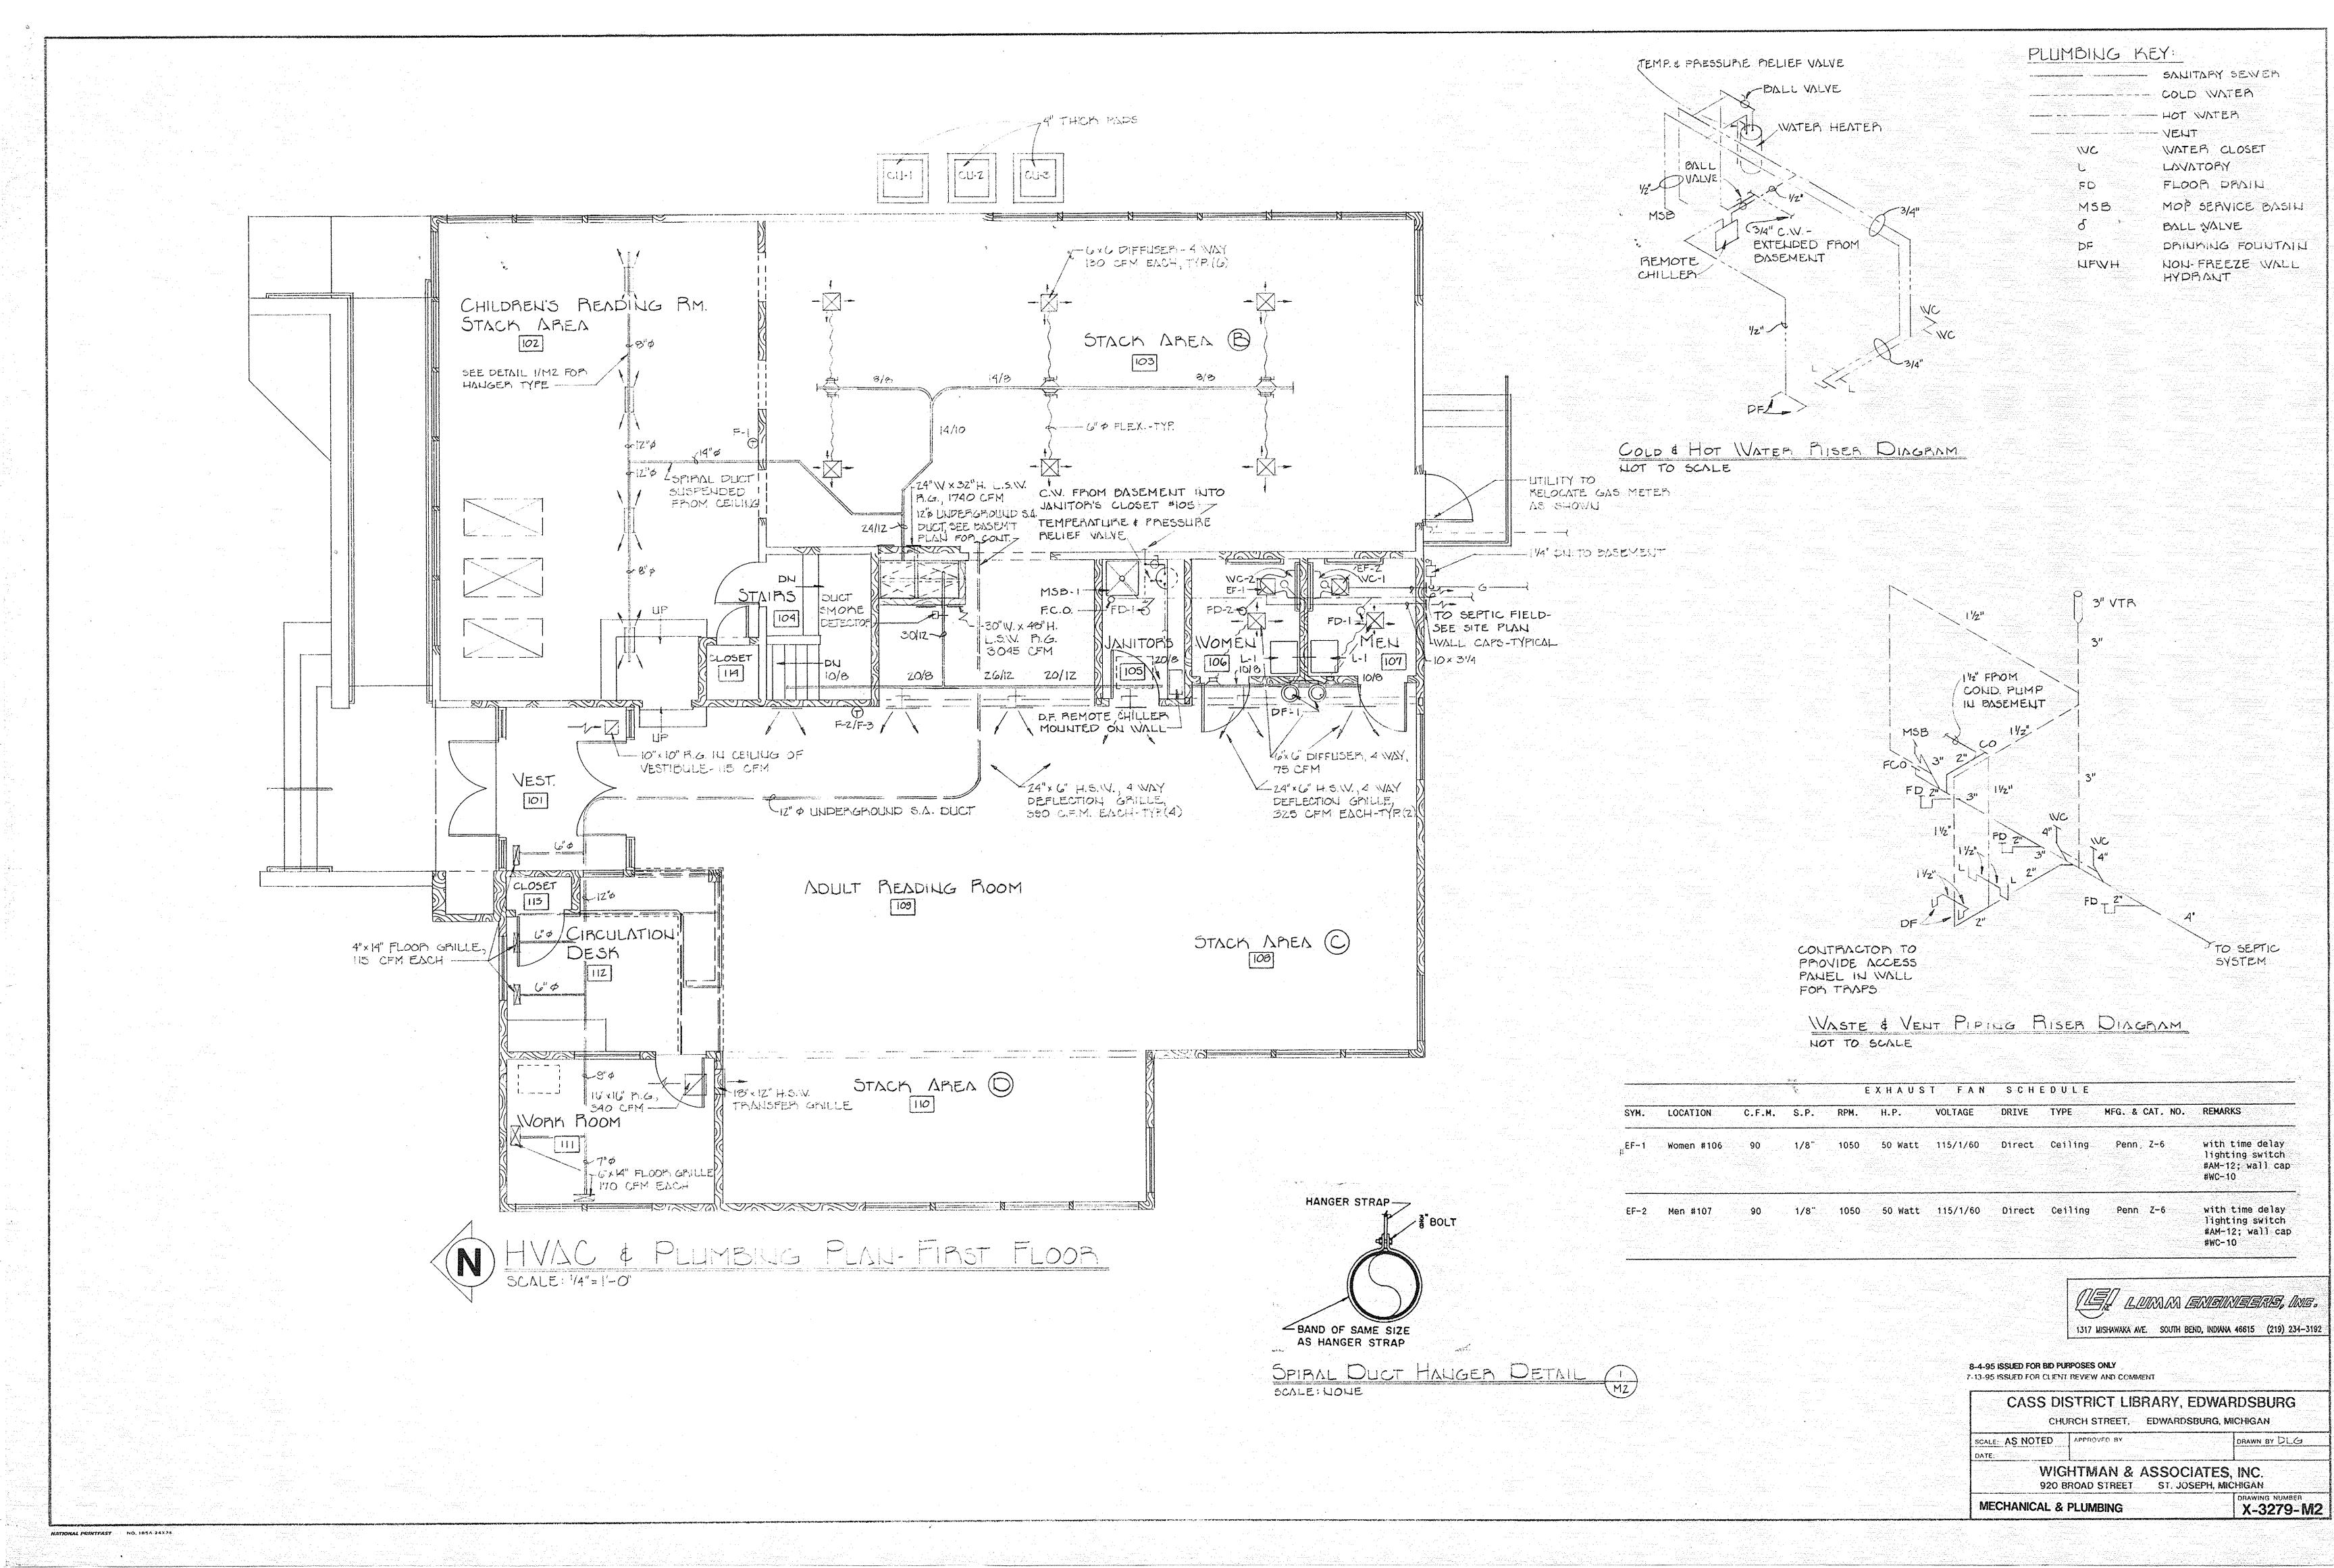

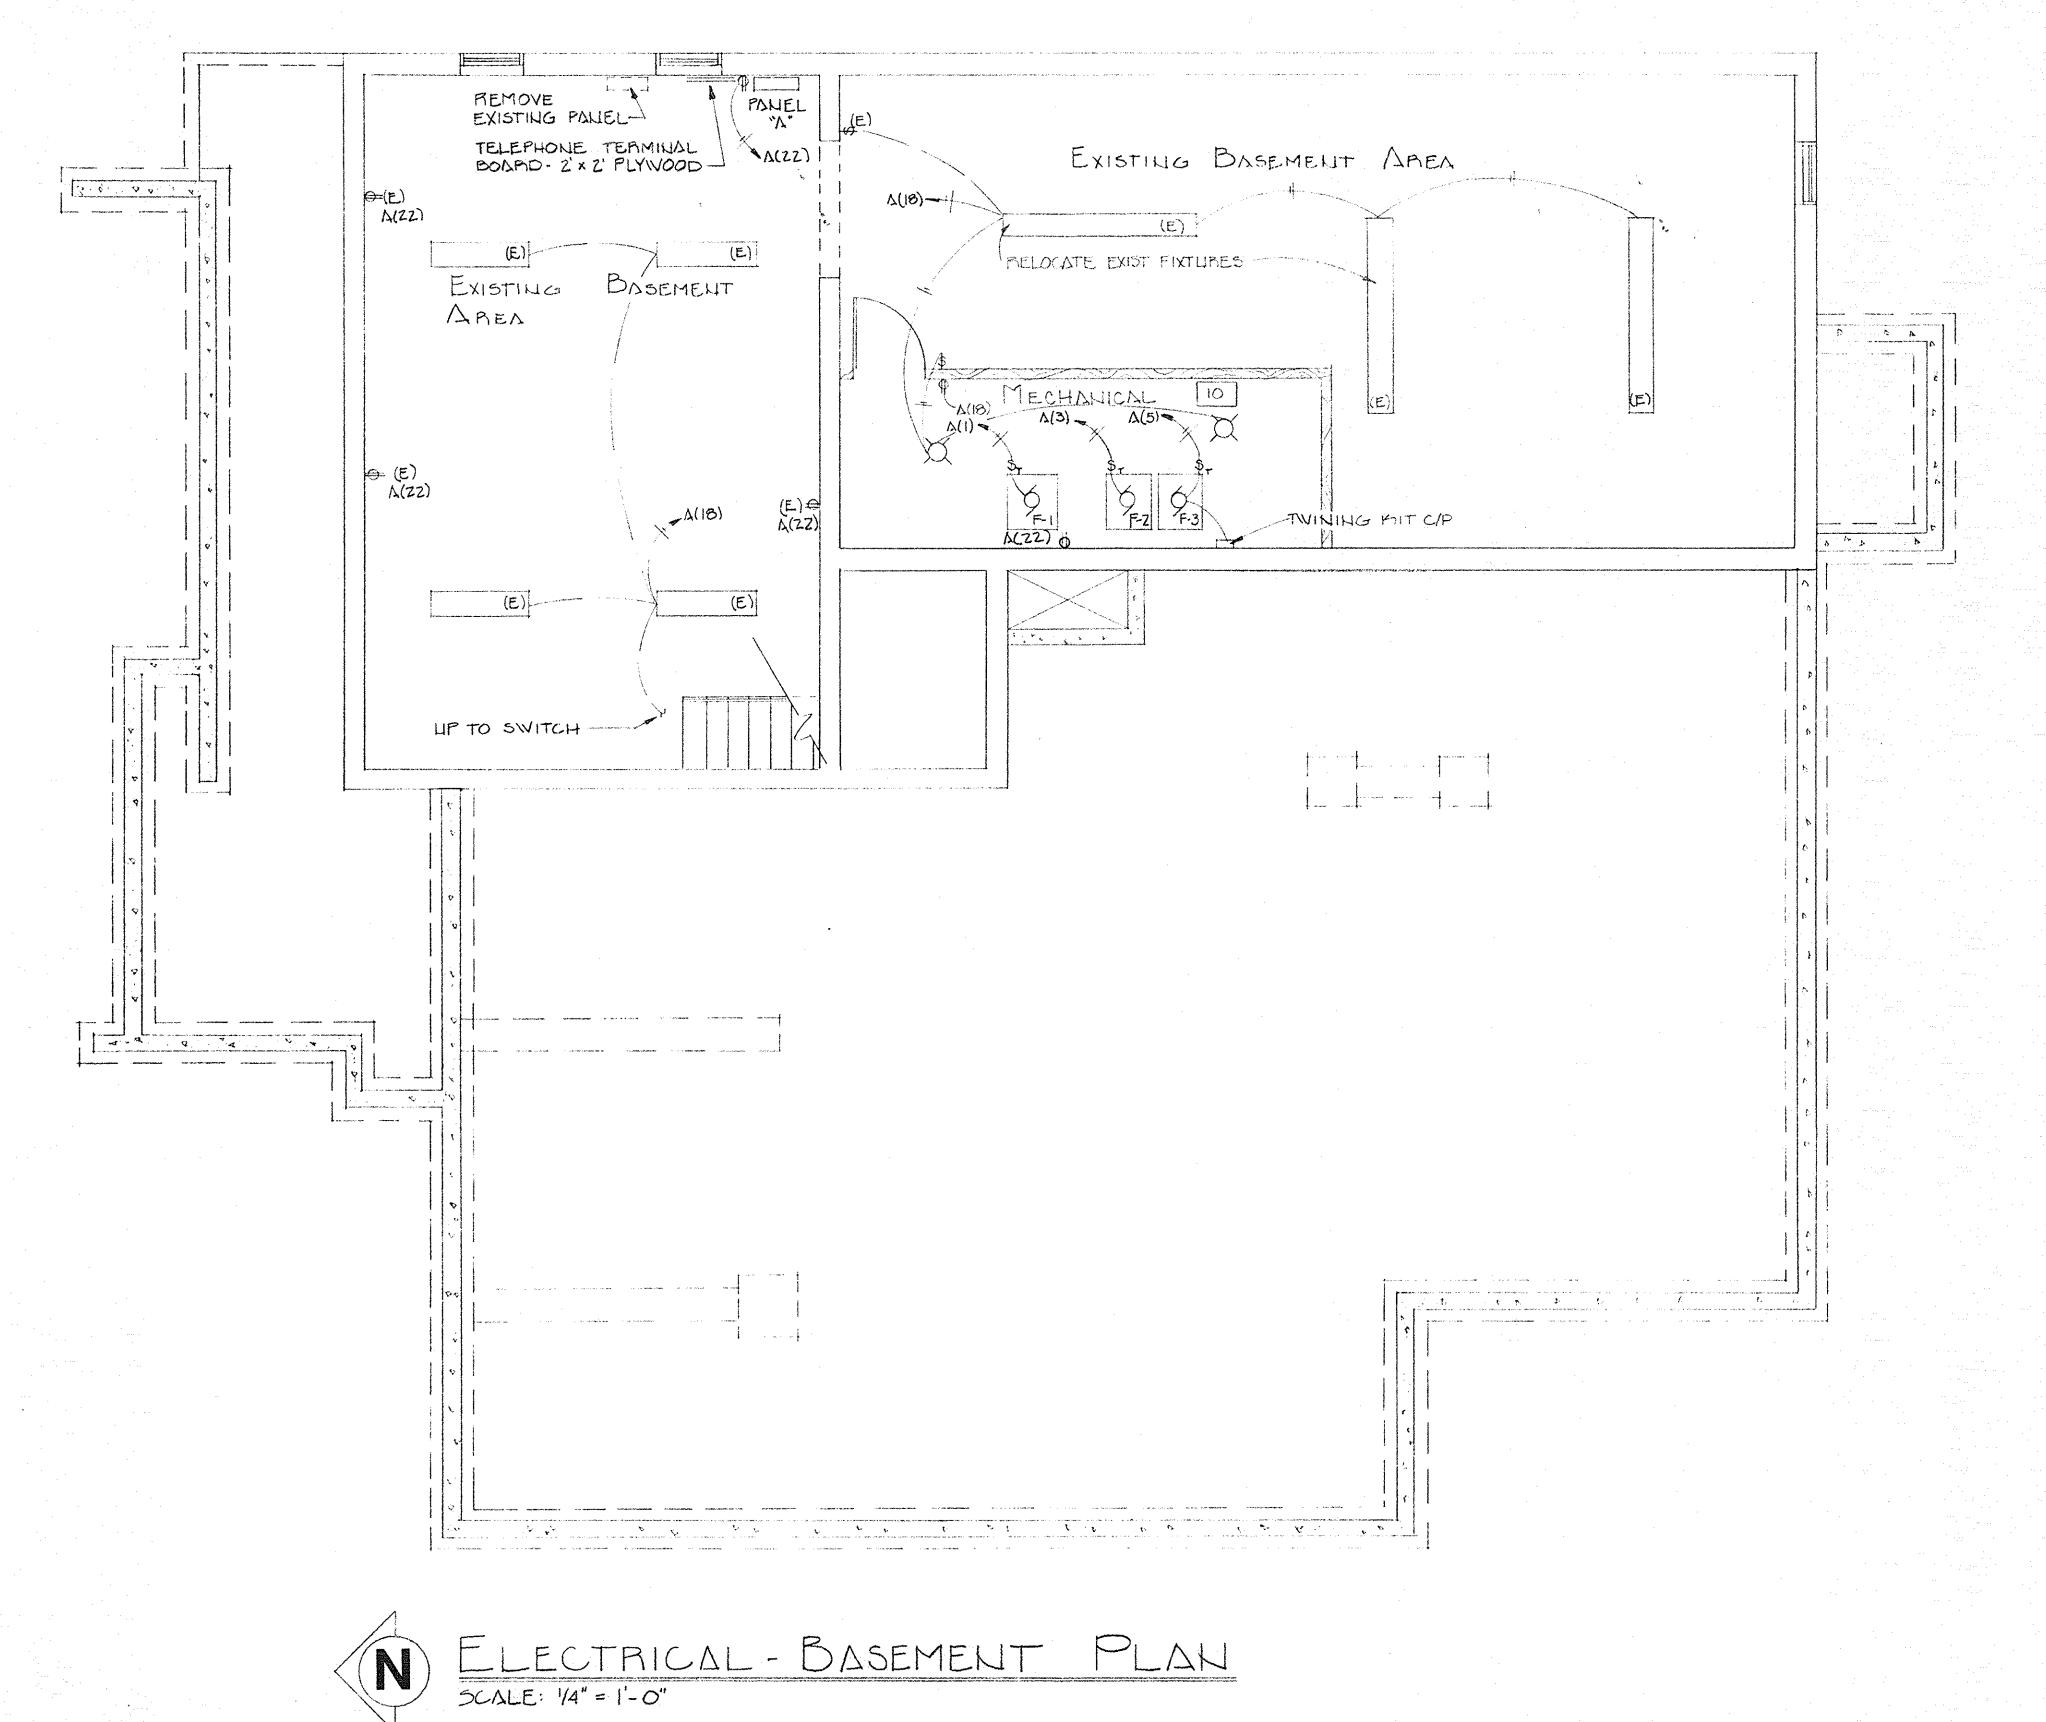


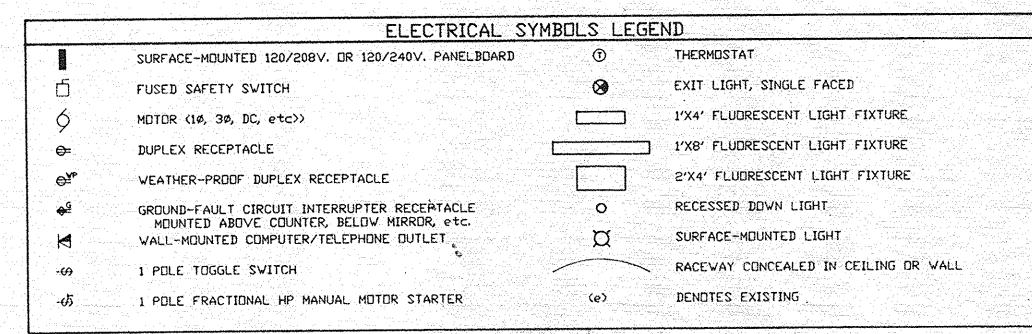

٦	VA L	-	LOAD DESCRIPTION		TLETS		DECLET SEARCH	BUS	CMOAT		UTLETS	ACE WITH 4-500 MC	VA L	DAD	cx:
	LINE A	وبر مع بعدو مساحي من يون سيدران المنطقة المناورات		-	ACC LTI			A J	and the second second second	*****	t set me	Note that the second of the Se			No
П	1656		FURNACE F-1 3/4 HP	x		1	20	H				WATER HTR.	1500	A company	a
3	1		FURNACE F-2 3/4 HP	X		1	وتيب والمستند والم			ŤÍ		RM. 109 ×		1770	4
5	1656		FURNACE F-3 3/4 HP	Х		1	50	-	100	11	(RM. 109 ×	1770	ANTONIO.	€
7		3350	COND. UNIT CU-1	X		2	50			11>		RM. 109 *	er a serena i	1245	8
7	3350			X				-	BU (24)	11>	(2 5	RM. 102	1500		1(
П		2760	COND. UNIT CU-2	X		5	50			115	()	RM. 103 & EXTERIOR LTG.		700	18
	2760	Fig. Care		X		17		\Box		$\Pi 7$		RM. 105,106,107,& 109	920		14
Π	ĺ	2760	COND. UNIT CU-3	X		15	50			$\Pi \mathfrak{d}$	(1)	RH. 101,111,112,& EXTERIOR LTG.		1700	16
٦	2760	-		X		$\overline{\mathcal{C}}$		H		Π	()	EXIST. BASMT, AREA	1000		18
7		900	RM. 109		X	1	50	- +		П	X	RM. 103 (EXIST: RECEPTS.)	tegra, alignet e reconsplit	360	2(
	540		RM. 105, 106, &107		XI			-	258 25		Х	EXIST: BASMT, AREA	900	tay alah	22
3	10.00	1080	RM. 109	- 1 22	Χ	TT				П	Χ	RM. 110 & 111		720	24
5	720		RM. 111 & 112		X		- C			П	Χ	RM. 111 & 112	720		56
	1 7111	180	EXTERIOR RECPT.		X	II				П	X	SPARE		am sale i jakun Maskari jajing	28
)			SPARE			ТГ			10 m 10 m 10 m 10 m	П	X	SPARE			3(
		e e dad e	SPARE			1	111			\mathbf{H}	X	ISPACE			36
3		aryat 14 s	SPACE			T		-							3
5	a Parting							Η.			. 🔅 .		Şorturu,	Service Co	36
		\$ \$# \dags	The second of the second of			- 1.,		-	Y. Y		1 100		al est of the		38
2							: -		Ξ.						4
		11. S						-	osse, laden						42
	13442	12686	the control of the co				3	דסד פטי	ALS					6495	1
Ť	EZ I					, , , , , , , , , , , , , , , , , , , 				17. ž.,		LINE TOTALS	21752	19.181	
		15686					3	יטד פטי	ALS	n v Nafy		LINE TOTALS LCL ADDER			t

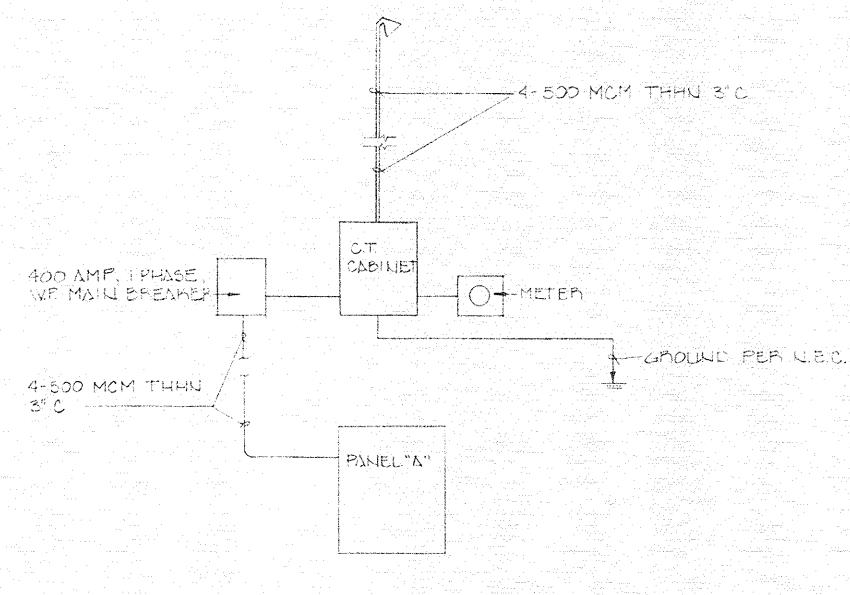


ONE LIVE DIAGRAM 120/240 V , I PHASE, 3 WIRE, 400 MMP

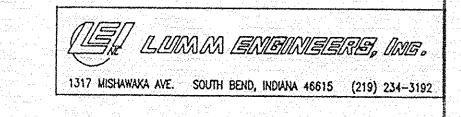


7-13-95 ISSUED FOR CLIENT REVIEW AND COMMENT

CASS DISTRICT LIBRARY, EDWARDSBURG


WIGHTMAN & ASSOCIATES, INC. 920 BROAD STREET ST. JOSEPH, MICHIGAN X-3279-E1 ELECTRICAL

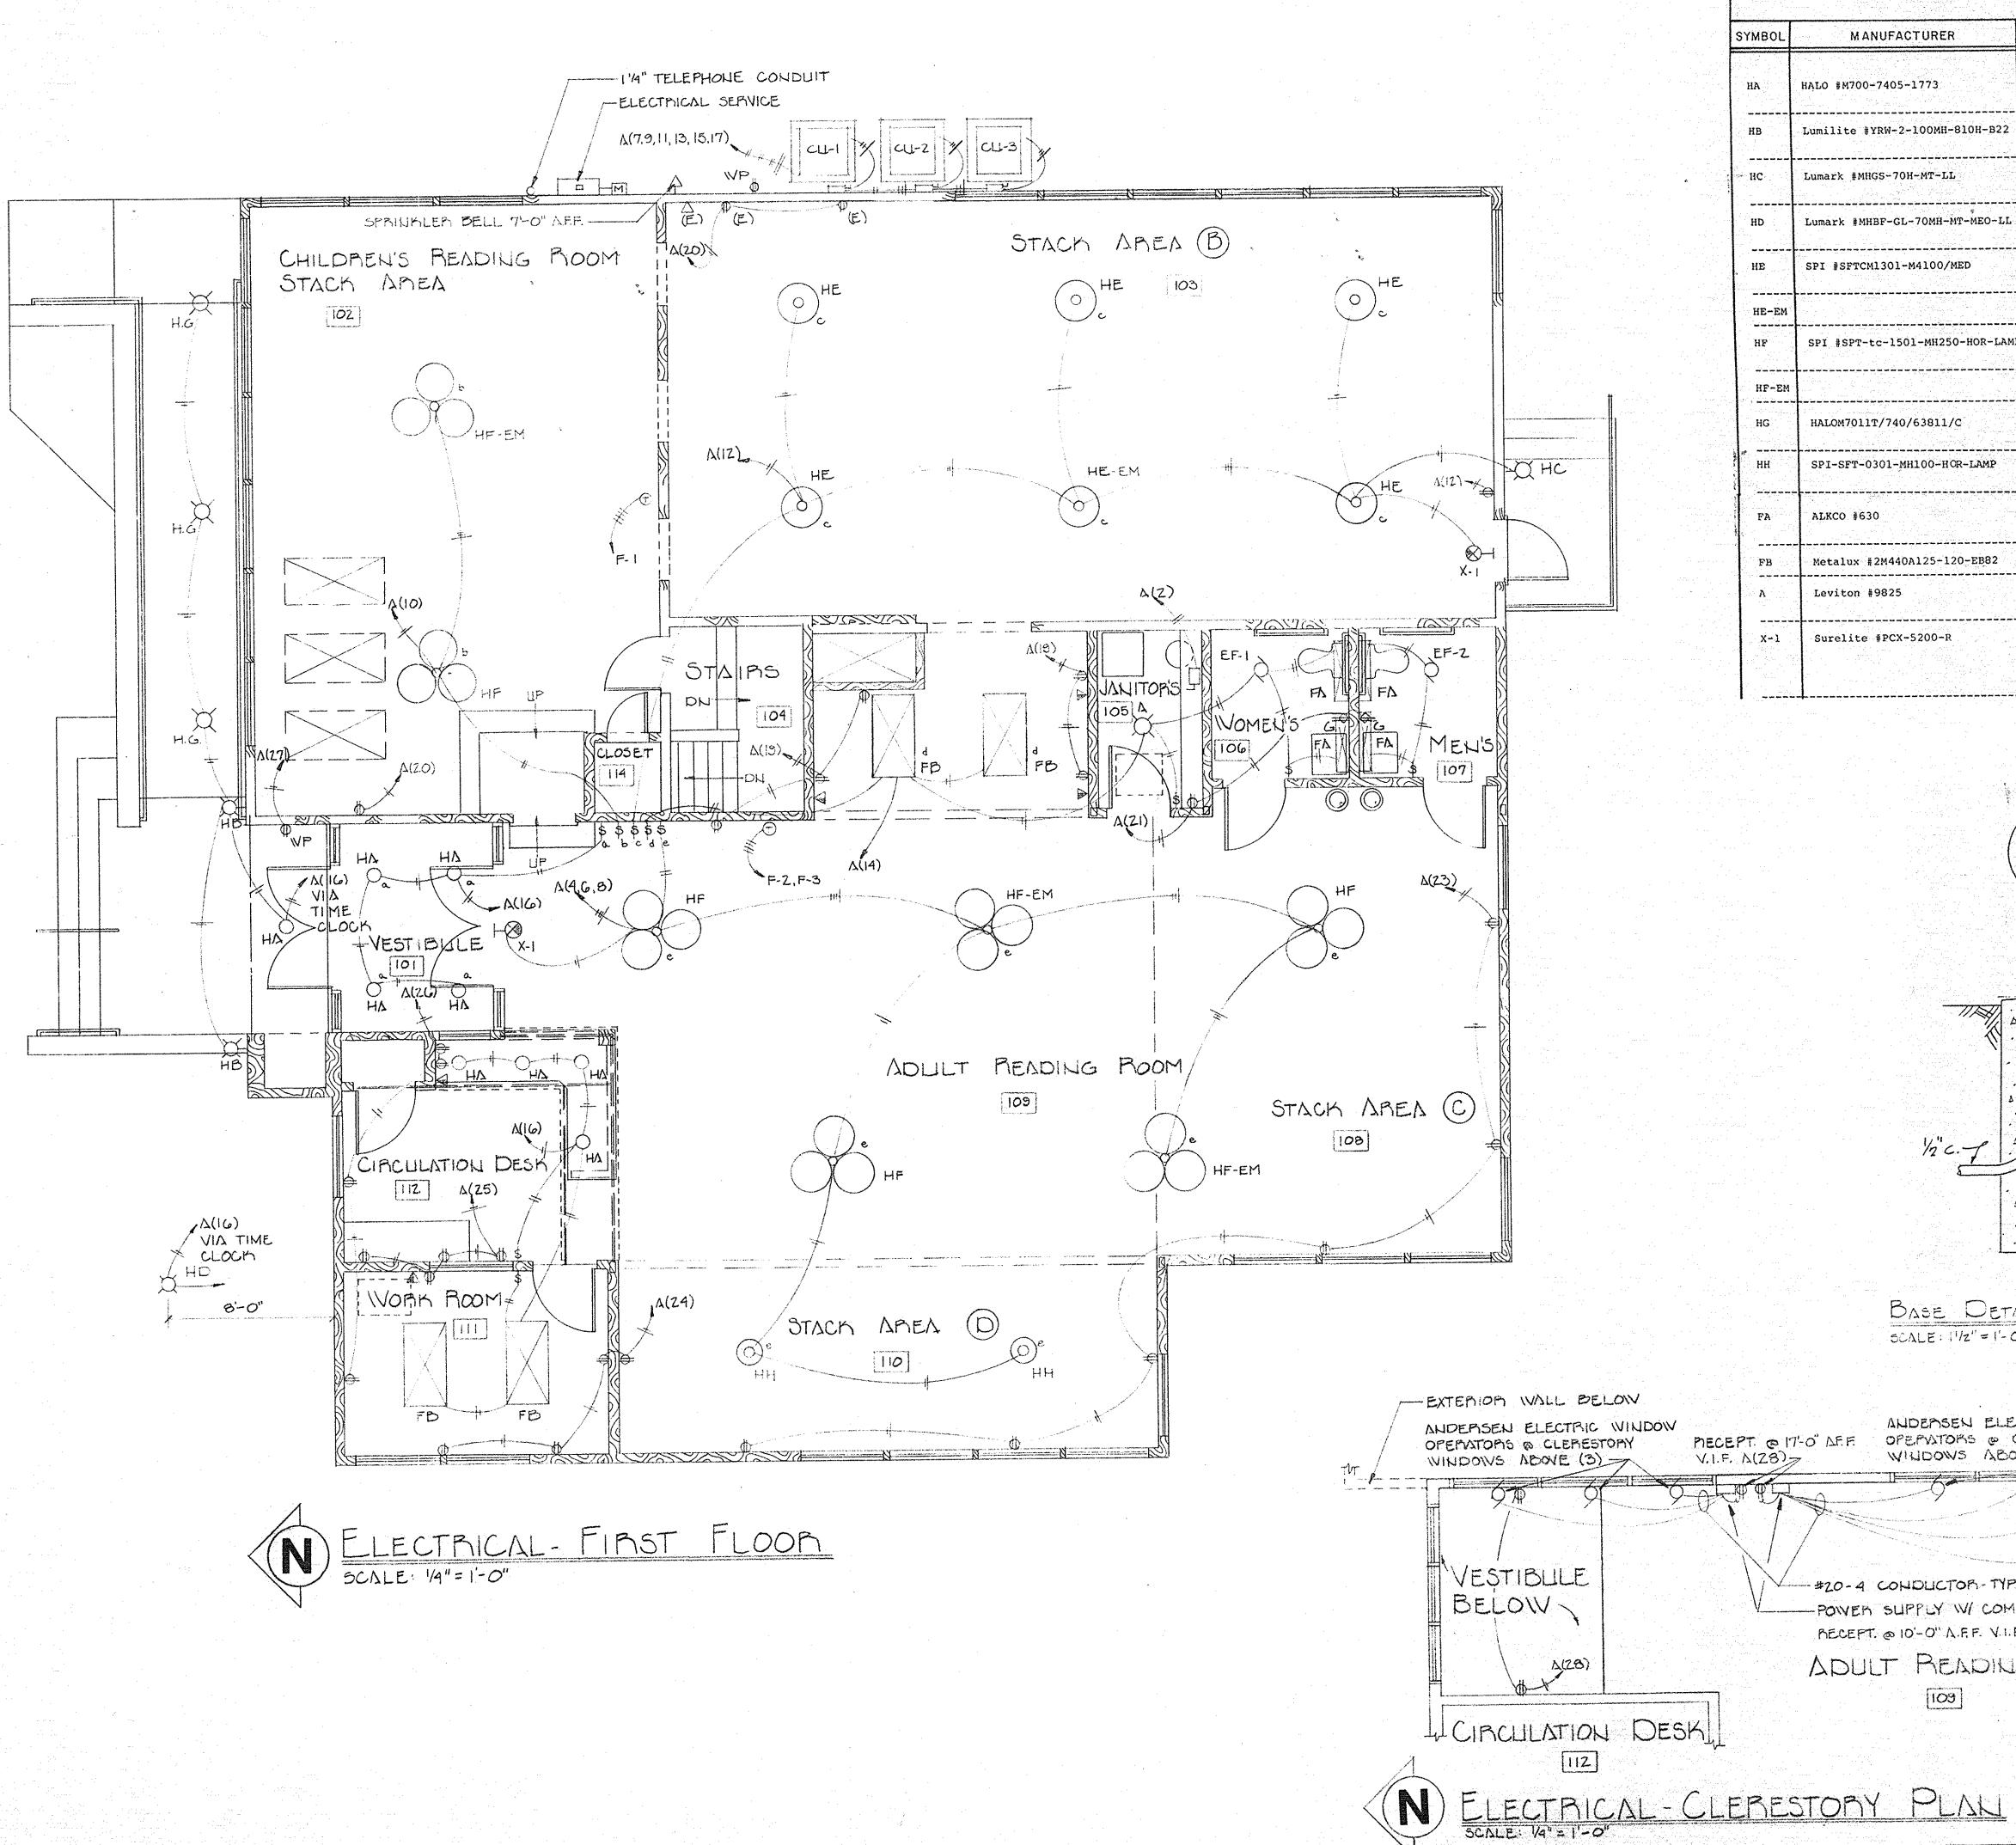

T					DEMARKS		
YMBOL	MANUFACTURER	LAMPS	TYPE	MOUNTING	REMARKS		
на	HALO #M700-7405-1773		70 W. Metal Halide	-Recessed	White Trim - Fresnel Lens		
нв	Lumilite #YRW-2-100MH-810H-B22	2	70 W. Metal Halide	Wall @ 7'-0" AFF	Custom Color		
нс	Lumark #MHGS-70H-MT-LL		70 W. Metal Halide	Wall 0 8'-0" AFF	with Photocell Custom Color		
HD	Lumark #MHBF-GL-70MH-NT-MEO-LL	1	°00 W. Metal Halide	Grade	Custom Color		
HE	SPI #SFTCM1301-M4100/MED		100 W. Metal Halide	🕊 konskiller og konstrument (f. 1778) er en og likeligt kombet (bl. 1878) er en ble 🛊	Brass_Trim		
не-ем					Same as "HE" with EM Quartz		
HF	SPI #SPT-tc-1501-MH250-HOR-LAMP	3	250 W. Metal Halide		Ceiling Height Varies Brass Trim, Painted Pendant		
HF-EM					Same as "HF" with 1-EM Quartz		
HG	HALOM7011T/740/63811/C	1	100 W. Metal Halide	Recessed in Soffit	Wall Wash with Reverse Lens to Cover Ramp.		
нн	SPI-SFT-0301-MH100-HCR-LAMP	1	100 W. Metal Halide	Pendant 9'-0" AFF	Ceiling Height Varies, Brass Trim, Painted Pendant		
FA	ALKCO #630		F25T8SP41	Wall @ 6'-6" Fin. Fl. to Bot. Fix. Verify Mirror Ht.	Wall Bracket		
FB	Metalux #2M440A125-120-EB82	4	F32T8SP41	Ceiling	2 x 4 Surface		
λ	Leviton #9825	1 1 1 1 1 1 1 1 1 1 1 1 1 1 1 1 1 1 1	100 W. A-19	Ceiling	Porcelain Receptacle		
X+1	Surelite #PCX-5200-R	2	5 W Fluorescent 3.6 W. DC Lamps	Wall 0 8'-0" AFF			

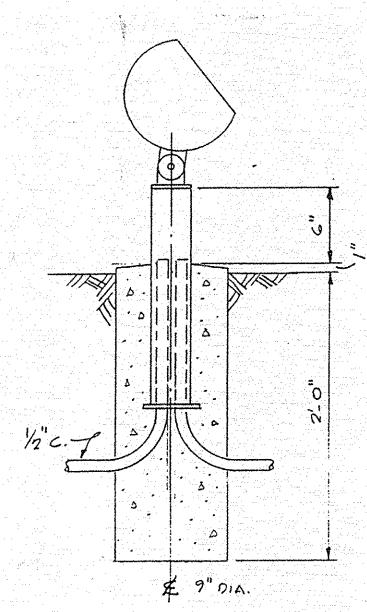

BASE DETAIL FOR FIXTURE 'HD'

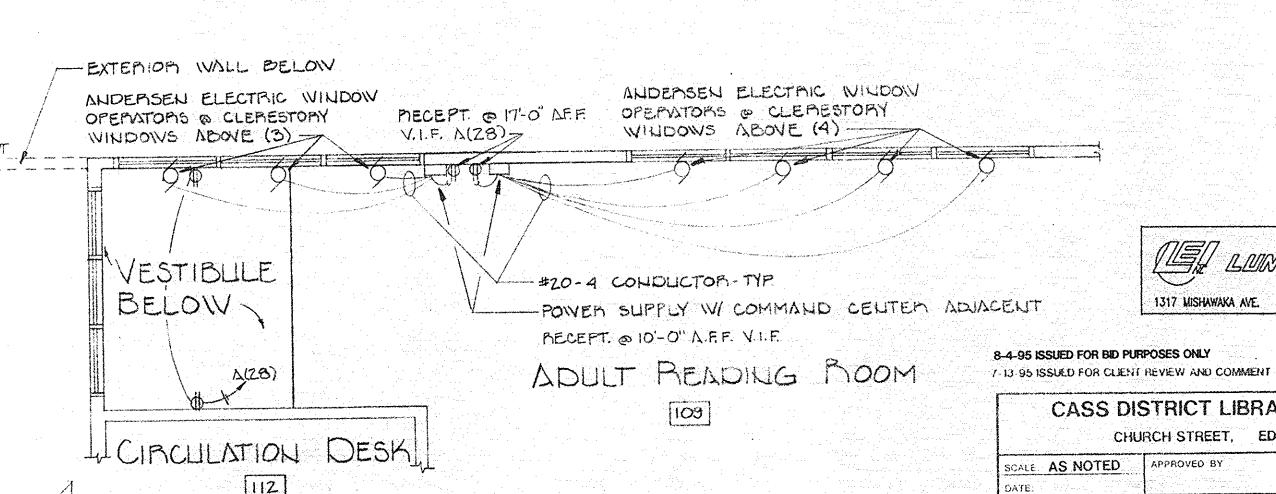

LUMM ISMBINISERS, ING.

8-4-95 ISSUED FOR BID PURPOSES ONLY

CASS DISTRICT LIBRARY, EDWARDSBURG CHURCH STREET, EDWARDSBURG, MICHIGAN DRAWN BY DLG

WIGHTMAN & ASSOCIATES, INC.
920 BROAD STREET ST. JOSEPH, MICHIGAN DRAWING NUMBER
X-3279-E2

ELECTRICAL